

85-109 Farm Road Stage 02B

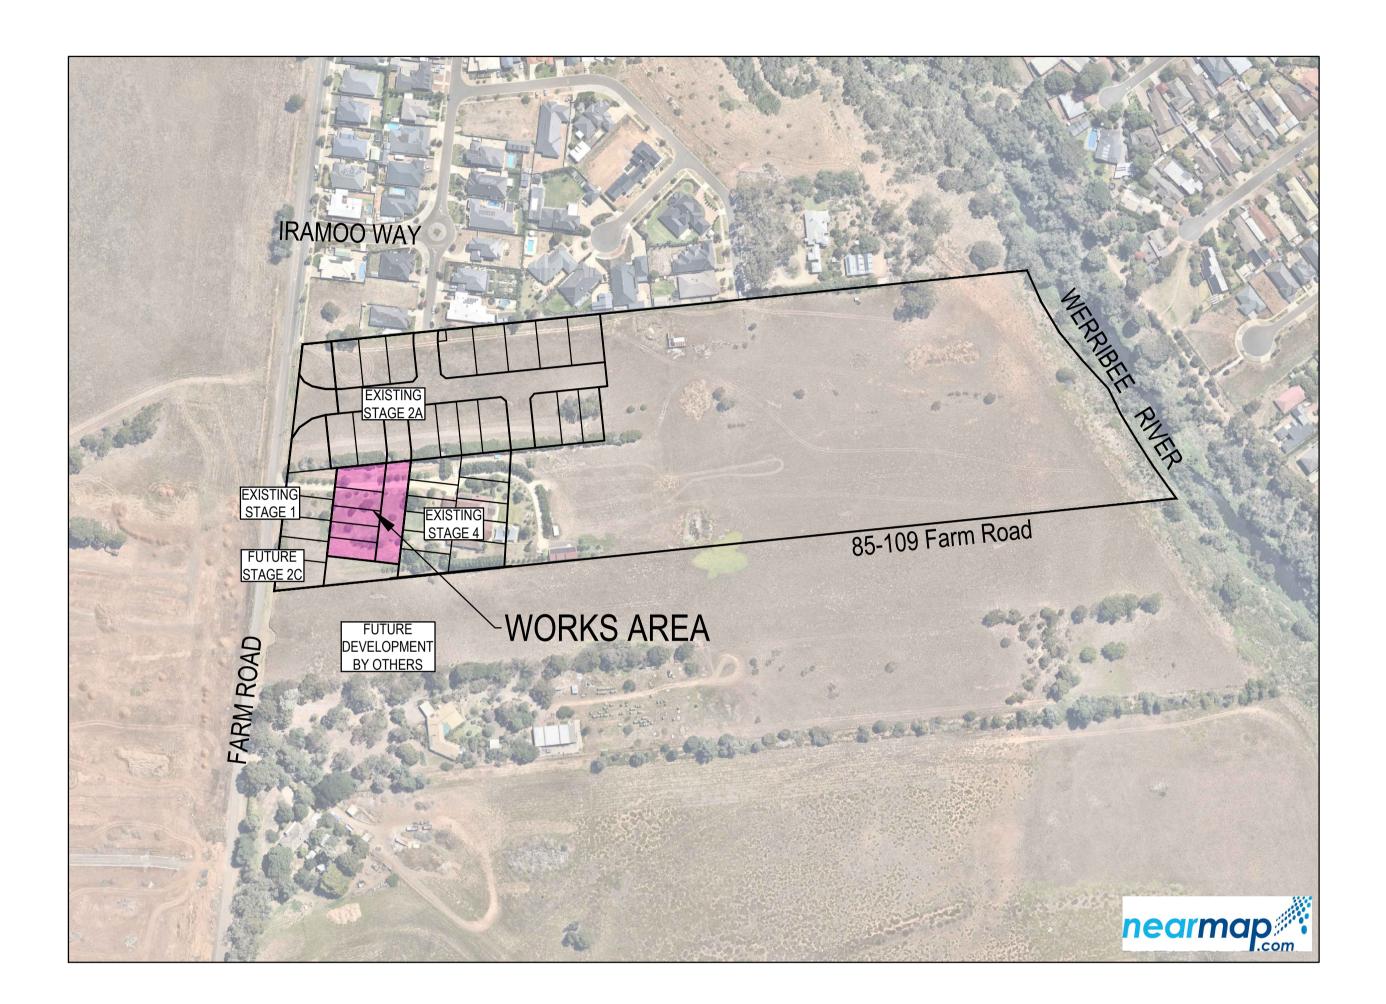

Drawing Index

2053E-02B-01 Cover Plan 2053E-02B-02 Layout Plan 2053E-02B-03 Longitudinal Sections 2053E-02B-04 Road Cross Section From CH:69.98 to 137.29 2053E-02B-05 Drainage Longitudinal Section and Pit schedule 2053E-02B-06 Pavement Details 2053E-02B-85 Safety In Design

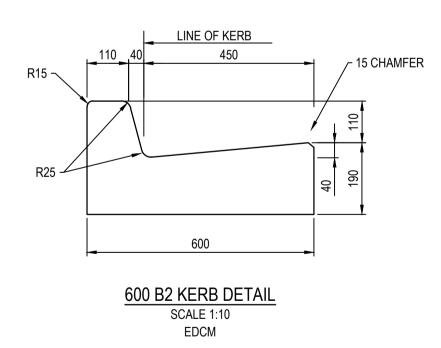

SURVEY CONTROL POINTS RL (AHD) **EASTING** NORTHING DESCRIPTION 18.22 293237.37 5800882.04 STEEL STAR PICKET C9SSPL C40SSPL 293242.18 5800884.63 18.26 STEEL STAR PICKET C21RVTCL 293266.31 5801094.97 18.55 **RIVET** C22RVTCL 293276.24 5801175.39 18.62 **RIVET** 18.21 STEEL STAR PICKET C39SSPL 293350.40 5801101.06 293354.13 5801168.79 19.10 **RIVET** C26RVTKL 293484.83 17.92 STEEL STAR PICKET C10SSPL 5800898.68 17.61 C41SSPL 293524.55 5800949.00 STEEL STAR PICKET 18.08 C3PM39L 293233.84 5800809.86 PERMANENT MARK

WARNING

BEWARE OF UNDERGROUND SERVICES their exact position should be proven on site.

The locations of underground services are approximate only and No guarantee is given that all existing services are shown. ocate all underground services before commencement of works **DIAL 1100 BEFORE YOU DIG** www.1100.com.au

SAFETY MEASURES REQUIRED

Please note there are risks attached to the construction of this project, and any ongoing maintenance of structures. Consider the safety of all. For potential risks, consequences and controls refer to Safety In Design Risk Register SID P4.E6. 2053E-2B-85 ASSESS THE RISK - STAY SAFE

AS CONSTRUCTED PLANS

The purpose of these as-constructed plans is to update the design drawings to show significant changes which occurred during construction. Note that the levels shown on these plans are design levels, and have not been verified by survey. All information shown on these plans should be verified on site. SMEC Australia Pty Ltd accept no responsibility for loss or damages resulting from the inappropriate usage of these plans.


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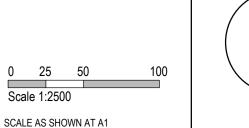
All setting out should be carried out in accordance with MPA/Council's standard drawings or as nominated on hard copy plans provided by SMEC. Any digital information supplied by this office is for information only. Any discrepancies should be discussed with the superintendent.










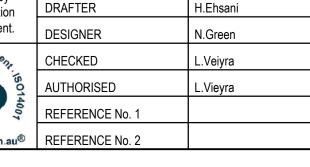

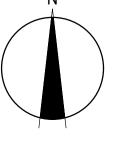



Ph 03 9514 1500



GENERAL NOTES (WYNDHAM CITY COUNCIL)

1. THE WORKS SHALL BE CONSTRUCTED IN ACCORDANCE WITH THE CURRENT EDCM ADDENDUM STANDARD DRAWINGS AND SPECIFICATIONS. WORKS TO BE CARRIED OUT TO THE SATISFACTION OF COUNCIL'S SUPERVISING

2. THE CONTRACTOR IS RESPONSIBLE FOR SAFETY OF WORK ON SITE IN ACCORDANCE WITH APPROPRIATE LEGISLATION. THE CONTRACTOR SHALL ERECT AND MAINTAIN ALL SHORING, PLANKING AND STRUTTING, DEWATERING DEVICES, BARRICADES, SIGNS, LIGHTS, ETC. NECESSARY TO KEEP WORKS IN A SAFE AND STABLE CONDITION, AND TO PROTECT THE PUBLIC FROM HAZARDS ASSOCIATED WITH THE WORKS.

THE CONTRACTOR SHALL: 3.1. COMPLY WITH THE SAFETY REQUIREMENTS OF THE MINES ACT, GENERAL REGULATIONS AND STATUTORY

RULES. AND THE MINES (TRENCHES) REGULATIONS 1982. NOTIFY THE OCCUPATIONAL HEALTH AND SAFETY AUTHORITY OF HIS INTENTION TO COMMENCE TRENCHING

OPERATIONS WHERE TRENCHES ARE 1.5 METRES OR DEEPER. ENSURE THAT THE MINE MANAGER OR HIS DEPUTY AS REQUIRED BY THE REGULATIONS IS IN ATTENDANCE

WHEN TRENCHING OPERATIONS ARE IN PROGRESS.

4. THE CONTRACTOR IS TO NOTIFY COUNCIL AND ALL SERVICE AUTHORITIES SEVEN (7) DAYS PRIOR TO COMMENCEMENT OF CONSTRUCTION.

5. THE LOCATION OF EXISTING SERVICES SHOULD BE DETERMINED BY THE CONTRACTOR PRIOR TO COMMENCING ANY EXCAVATION BY CONTACTING ALL RELEVENT SERVICE AUTHORITIES. ANY EXISTING SERVICES SHOWN ON THE DRAWINGS ARE OFFERED AS A GUIDE ONLY AND ARE NOT GUARANTEED AS CORRECT.

6. TREES MARKED ON THE APPROVED PLANS FOR REMOVAL MUST BE REMOVED FROM THE SITE PRIOR TO THE COMMENCEMENT OF WORKS. NO EXCAVATION SHALL BE CARRIED OUT WITHIN 5.0m OF ANY EXISTING TREE UNTIL APPROVAL HAS BEEN GIVEN BY COUNCIL'S SUPERVISING OFFICER.

7. ALL ROAD CHAINAGES ARE MEASURED ALONG THE ROAD CENTRELINE EXCEPT KERB RETURNS AND COURTHEADS, WHERE LIP OF KERB CHAINAGES ARE SPECIFIED. ALL DIMENSIONS AND RADII ARE GIVEN TO THE LIP OF KERB. DO NOT SCALE OFF THESE DRAWINGS, WRITTEN DIMENSIONS ONLY SHALL BE USED.

8. CONDUIT LOCATIONS ARE SUBJECT TO AMENDMENT AND CONDUITS SHALL NOT BE LAID UNTIL WRITTEN APPROVAL IS GIVEN BY THE SUPERINTENDENT. BOTH KERBS ARE TO BE MARKED WITH THE LETTERS E,G,H,R,T&W ABOVE CONDUIT LOCATIONS AS SPECIFIED. RESPECTIVE LETTERS TO BE INDICATED ABOVE RELEVANT CONDUITS AS PER STANDARD DRAWING EDCM 303. CONDUITS TO BE PLACED MINIMUM OF 5m FROM BOUNDARIES WHERE POSSIBLE AND TO THE SATISFACTION OF THE SUPERINTENDENT IN ACCORDANCE WITH COUNCIL STANDARD DRAWINGS.

9. SUBSOIL DRAINS SHALL BE INSTALLED BEHIND OR BELOW ALL KERB AND CHANNEL AS PER STANDARD DRAWINGS EDCM 202 (EXPANSIVE SUBGRADE).

10. ALL LINEMARKING, SIGNING AND TRAFFIC CONTROL DEVICES TO BE IN ACCORDANCE WITH VICROADS REQUIREMENTS WITH LATERAL WORKS AND ARROWSBEING COLD APPLIED PLASTIC TROWELLED INTO PLACE (MATERIAL DEGAOUR OR PLASTELINE) AND LONGITUDINAL LINES BEING EXTRUDED THERMOPLASTIC MATERIAL (VICROADS SPECIFICATION SEE SECTION 710&722).

11. ALL LEVELS ARE TO AUSTRALIAN HEIGHT DATUM.

12. THE CONTRACTOR WHEN ENGAGED IN BLASTING OPERATION, SHALL NOT BLAST WITHIN 4.5m OF AN EXISTING LINE OF WATER, GAS OR SEWER PIPES OR WITHIN 15m OF ANY COMPLETED PART OF THE WORKS WITHOUT THE

13. ALL EXCAVATED OR FILLED AREAS OUTSIDE THE ROAD RESERVES SHALL BE SURFACED WITH A 100mm MINIMUM TO 200mm MAXIMUM LAYER OF TOPSOIL AS SPECIFIED. ALL FILLING ON ALLOTMENTS TO BE COMPACTED TO 95% STANDARD COMPACTION IN 150mm LAYERS AND AS PER THE SPECIFICATION. WHERE THERE IS FILL IN EXCESS OF 300mm IN DEPTH. THE CONTRACTOR IS TO CARRY OUT SOIL TESTS TO THE REQUIREMENTS OF APPENDIX B AS SPECIFIED IN THE AUSTRALIAN STANDARD AS 3798 TO SHOW THAT LEVEL 1 COMPACTION STANDARDS HAVE BEEN ACHIEVED. TEST RESULTS AND LOCATION OF TESTS FOR EACH ALLOTMENT SHALL BE APPROVED BY THE CONTRACTOR AND FORWARDED TO COUNCIL.

14. FILL MATERIAL USED UNDER PAVEMENTS AND FOOTPATHS MUST BE AN APPROVED MATERIAL TO THE STANDARD OF WYNDHAM CITY COUNCIL. ALL SUCH MATERIAL IS TO BE COMPACTED AS PER THE REQUIREMENTS OF THE SPECIFICATION APPROVED WITH THESE DRAWINGS PRIOR TO FORMWORK BEING PLACED. COMPACTION TESTS TO BE COMPLETED AND PROVIDED TO SUPERINTENDENT.

15. FILL & CUT BATTERS ARE NOT TO EXCEED 1 in 6 SLOPE, UNLESS SHOWN OTHERWISE.

16. ALL ALLOTMENTS SHALL BE SMOOTHED, GRADED AND SHAPED TO AN EVEN SURFACE WITH A MINIMUM FALL OF 1 in 150 TO THE DRAINAGE OUTLET SHOWN

17. ALL DRAINAGE PIPES ARE CLASS 2 RCP PIPES, RUBBER RING JOINTED UNLESS OTHERWISE SPECIFIED. 18. DRAINAGE PITS SHALL BE CAST MONOLITHICALLY. CEMENT RENDER SHALL ONLY BE USED TO REPAIR DEFECTS 19. BACKFILLING OF TRENCHES WHERE DRAINAGE AND SEWERAGE ARE IN CLOSE PROXIMITY ARE TO BE BACKFILLED

AS PER WYNDHAM CITY COUNCIL STANDARD DRAWING SD6-10. 20. ALL SERVICING TRENCHES UNDER ROADS, FOOTPATHS, DRIVEWAYS, PARKING BAYS ETC. ARE TO BE BACKFILLED WITH CLASS 2 F.C.R.

21. ALL HOUSE DRAIN CONNECTIONS ARE TO BE LOCATED NO CLOSER THAN 5.00m FROM THE SIDE BOUNDARY. 22. INVERT OF PROPERTY INLETS TO BE 500mm MINIMUM BELOW FINISHED SURFACE UNLESS NOTED OTHERWISE.

23. VEHICLE CROSSINGS TO BE CONSTRUCTED IN ACCORDANCE WITH STANDARD DRAWINGS EDCM 501 TO 503. DRIVEWAYS TO BE LOCATED MIN 0.75m FROM BUILDING LINE UNLESS SPECIFIED OTHERWISE AND CLEAR OF DRAINAGE PITS, SEWER MAINTENANCE HOLES AND EXISTING TREES. DOUBLE DRIVEWAY WIDTH TO BE 7.0m AT FRONT OF PATH/BUILDING LINE.

24. ADDITIONAL AND OVER-EXCAVATION SHALL BE BACKFILLED IN ACCORDANCE WITH THE PROVISIONS OF THE

25. FOOTPATH CROSSFALL TO BE 1:50 26. ALL FOOTPATHS AND SHARED PEDESTRIAN/BICYCLE PATHS ARE TO BE CONSTRUCTED AS PER CITY OF WYNDHAM SPECIFICATIONS AND MPA STANDARD DRAWINGS EDCM 401 TO 403.

27. ALL EXOTIC (NON NATIVE) TREES AND SHRUBS, INCLUDING DEAD TREES, NOT SHOWN ON THE DRAWINGS BUT

LOCATED WITHIN THE WORKS ARE TO BE REMOVED AND DISPOSED OFFSITE 28. INSTALL BLUE RAISED REFLECTIVE PAVEMENT MARKER (BRRPM) ON ROAD CENTRELINE AND "GROUND BALL"

MARKER POST TO INDICATE LOCATION OF FIREPLUG. 29. THE CONTRACTOR IS TO ENSURE THAT THEIR CONSTRUCTION PROCEDURES AND STANDARDS CONTROL THE VOLUME AND LOCATION FOR COLLECTION OF SEDIMENT RUNOFF ACCORDING TO CURRENT EPA - ENVIRONMENTAL

GUIDELINES FOR MAJOR CONSTRUCTION SITES. 30. UPON COMPLETION OF CONSTRUCTION THE WHOLE SITE SHALL BE CLEANED UP, GRADED AND ALL RUBBISH REMOVED. THE SITE IS TO BE LEFT IN A CLEAN AND TIDY CONDITION TO THE SATISFACTION OF THE

31. EXISTING PAVEMENT OR DRAINAGE WORKS DAMAGED DURING CONSTRUCTION OR THE MAINTENANCE PERIOD TO BE REINSTATED TO THE SATISFACTION OF THE COUNCIL ENGINEER.

32. THE LOWER SUB-BASE MATERIAL SHALL WILL BE N.D.C.R. FOR PAVEMENT MAKE UPS AS PER THE STANDARD

DRAWINGS OF WYNDHAM CITY COUNCIL. 33. TOTAL LENGTH OF ROADS CONSTRUCTED IS 63 m

TOTAL LENGTH OF DRAINS CONSTRUCTED IS 129 m

REINFORCED CONCRETE PIPE

ALL STORMWATER DRAINAGE PIPES SHALL NOT BE SUBJECTED TO CONSTRUCTION TRAFFIC LOADING DURING CONSTRUCTION UNLESS THE PIPE STRENGTH CHARACTERISTICS HAVE BEEN COMPUTED AND APPROVED BY THE


CONTRACTORS ENGINEER. COMPUTATIONS ARE TO ACCORD WITH AS.3725-2007, LOADS ON BURIED PIPES. 2. CONCRETE PIPES DAMAGED DUE TO CONSTRUCTION LOADS SHALL BE REPLACED & RELAID AT THE CONTRACTOR'S

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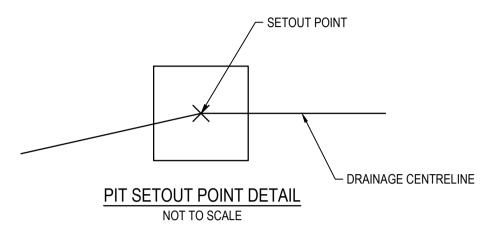
> > 85-109 Farm Road - Stage 2B Wyndham City Council Road and Drainage Cover Plan


MELWAYS REF PROJECT / DRAWING No. 205 G12 2053E-02B-01

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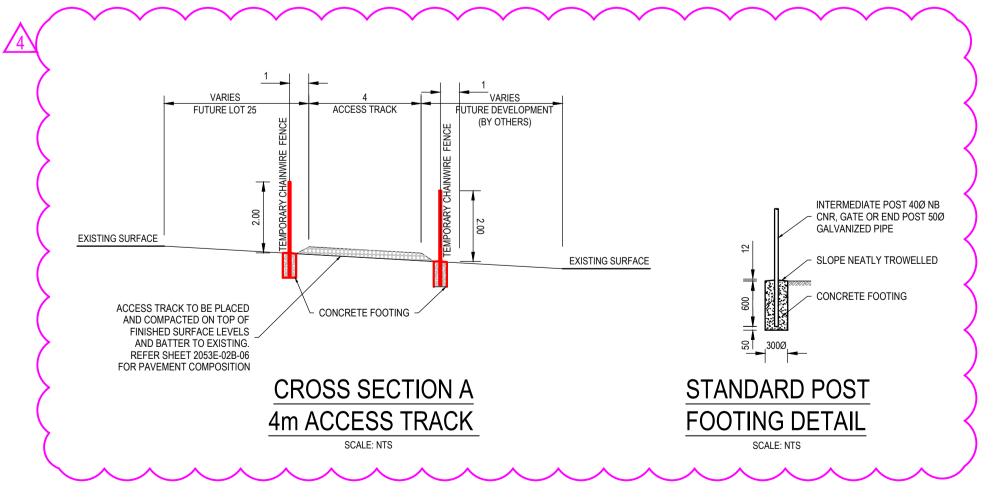
NOTE
ACCESS TO BE MANAGED FOR EXISTING LAND OWNER.
TO BE WORKED OUT BETWEEN CONTRACTOR AND OWNER.



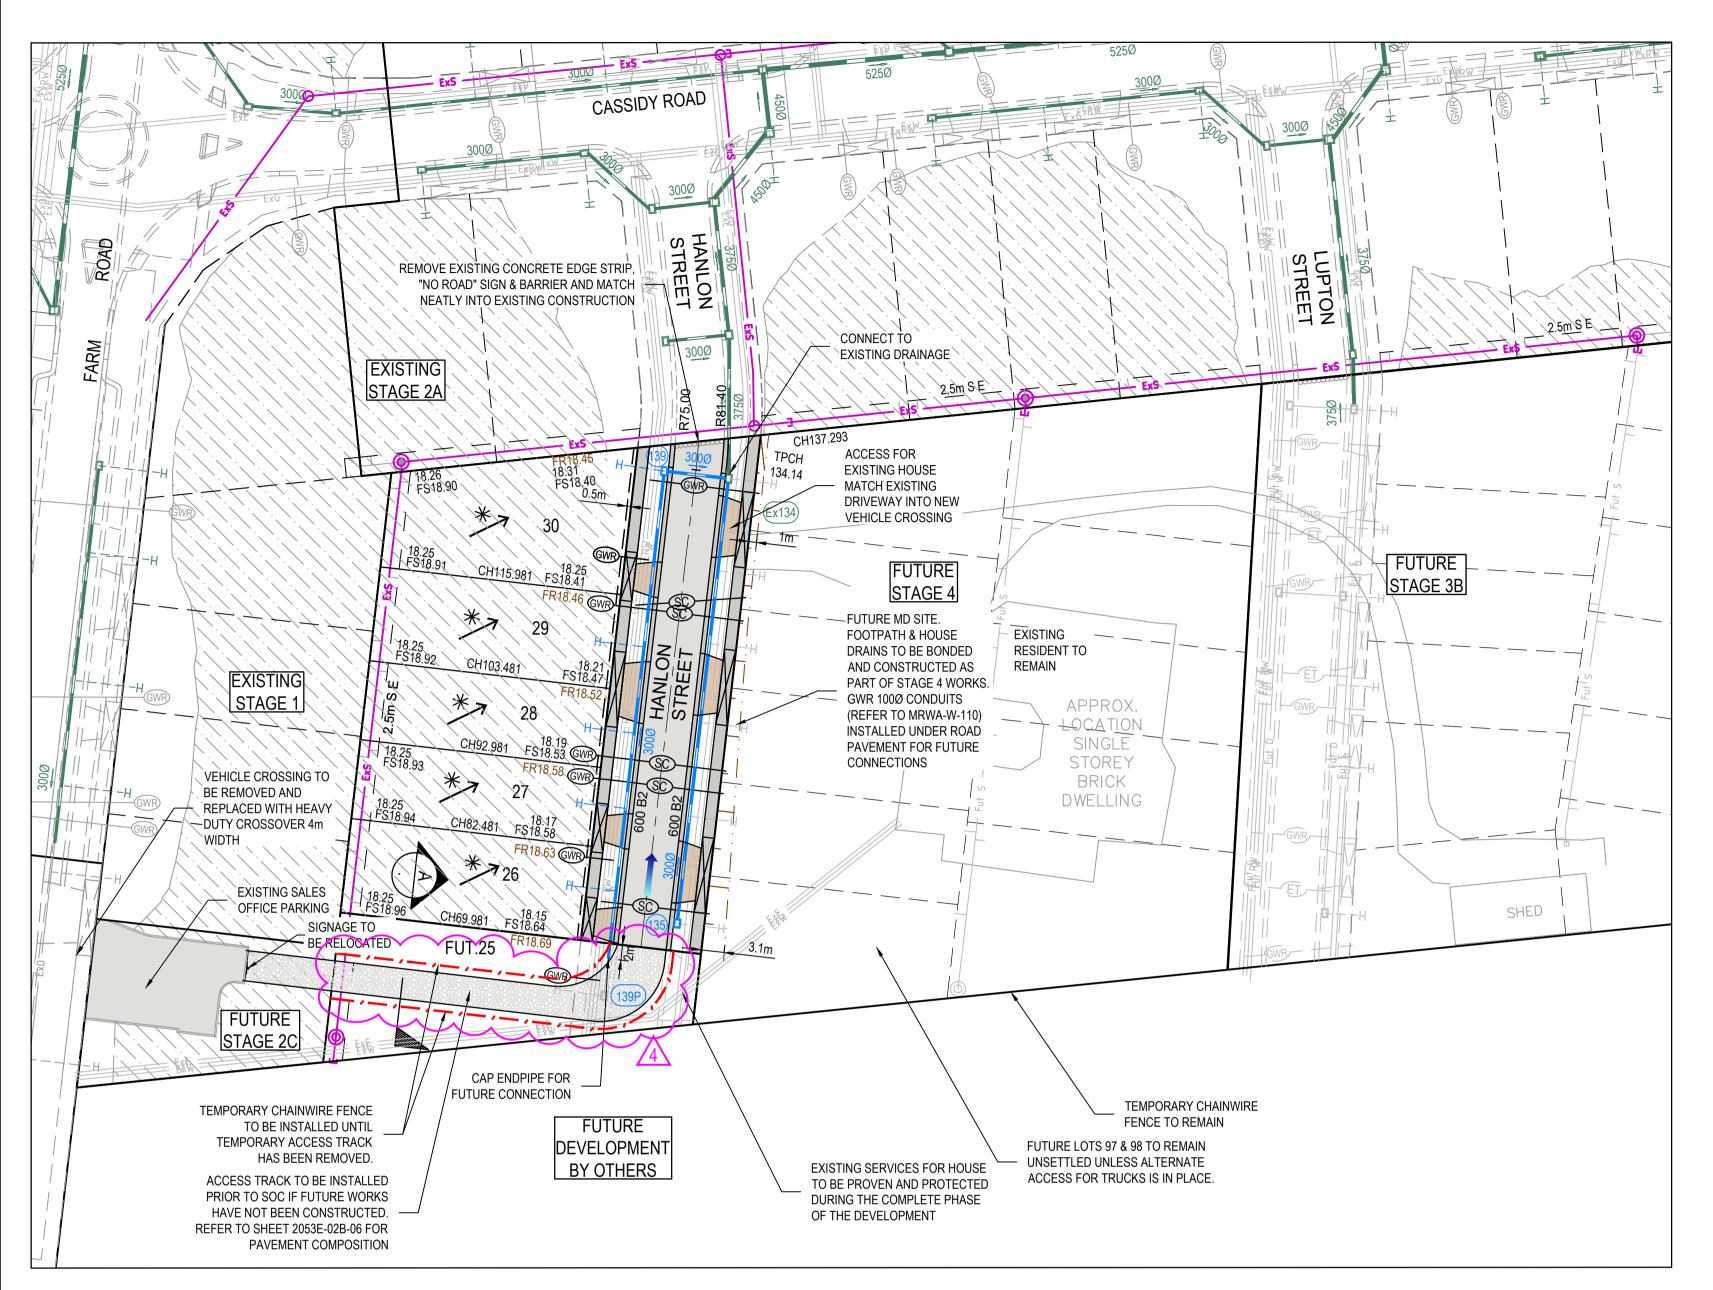

SERVICES OFFSET TABLE					
ROAD NAME	GAS	WATER	RECYCLED WATER	ELECTRICITY	OPTIC FIBRE
	OFFSET (m)	OFFSET (m)	OFFSET (m)	OFFSET (m)	OFFSET (m)
HANLON STREET	2.10 W	3.10 W	2.60 W	2.45 E	1.85 E

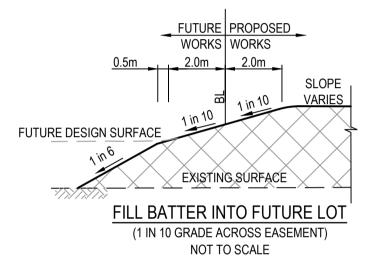ROAD LAYOUT TABLE								
RESERVE		R	OAD WIDTH (n	າ)	KERB TYPE VERGE WIDT			/IDTH (m)
ROAD NAME	WIDTH (m)	LIP to LIP	INV to INV	BACK to BACK	NTH/WEST	STH/EAST	NTH/WEST	STH/EAST
HANLON STREET	16.00	6.40	7.30	7.60	600 B2	600 B2	4.35	4.05



	STORMWATER DRAIN, PIT & PROPERTY INLET	
	MAIN DRAIN	
	SWALE DRAIN	
S	SEWER & MAINTENANCE STRUCTURES	
H	HOUSE DRAIN	
E	ELECTRICITY (U.GROUND)	
——0/H ——	ELECTRICITY (O.HEAD)	
—— G ——	GAS	
— т —	TELSTRA	
o	OPTIC FIBRE	
—— w ——	WATER	
	RECYCLE WATER	
—— Ag ——	AG. DRAIN	
—(GW)—	SERVICE CONDUITS	
	TACTILE PAVERS	
	EXISTING STORMWATER DRAIN	
	EXISTING MAIN DRAIN	
<u>>> -</u>	EXISTING SWALE DRAIN	
⊝ —Ех S——	EXISTING SEWER & MAINTENANCE STRUCTURES	
H	EXISTING HOUSE DRAIN	
——Ex E ——	EXISTING ELECTRICITY (UNDER GROUND)	
	· · ·	
—0/H E —	EXISTING ELECTRICITY OVERHEAD	
——Ex G ——	EXISTING GAS	
—Ex T—	EXISTING TELSTRA	
——Ex 0 ——	EXISTING OPTIC FIBRE	
——Ex W ——	EXISTING WATER	
—Ex RW —	EXISTING RECYCLED WATER	
——Ех.Ад ——	EXISTING AG. DRAIN	
GWR	EXISTING SERVICE CONDUITS	
	EXISTING TACTILE PAVERS	
	FUTURE STORMWATER DRAIN	
Fut D	FUTURE MAIN DRAIN	
<u>>> -</u>	FUTURE SWALE DRAIN	
⊖-FUT S	FUTURE SEWER & MAINTENANCE STRUCTURES	
H	FUTURE HOUSE DRAIN	
——fut E ——	FUTURE ELECTRICITY (UNDER GROUND)	
—Fut0/H E —	FUTURE ELECTRICITY OVERHEAD	
—Fut G —	FUTURE GAS	
—Fut T —	FUTURE TELSTRA	
—Fut 0 —	FUTURE OPTIC FIBRE	
—Fut W —	FUTURE WATER	
—Fut RW —	FUTURE RECYCLED WATER	
—Fut Ag —	FUTURE AG. DRAIN	
GWR	FUTURE SERVICE CONDUITS	
0 0 0 0 0	FUTURE TACTILE PAVERS	
	ZERO LOT LINES	
141.34	EXISTING SURFACE LEVEL	
FS140.35	FINISHED BUILDING LINE LEVEL	
FR157.40	FINISHED RIDGE LINE LEVEL	
CH270.00	CHAINAGE	
TW159.60	TOP OF RETAINING WALL LEVEL	
BW159.00	BOTTOM OF RETAINING WALL LEVEL	
BW 139.00	EXISTING RETAINING WALL	
	RETAINING WALL	
	FUTURE RETAINING WALL	
. \ .	STRUCTURAL FILL > 200mm DEEP	
17777	EXISTING STRUCTURAL	
	FILL > 200mm DEEP	
	CUT > 200mm DEEP	
	DIRECTION OF FALL	
	OVERLAND FLOW	
*	GRADED IN DIRECTION OF FALL TO LEVEL INDICATED	
·	EDGE STRIP, SUBSOIL DRAIN,	
	"NO ROAD" SIGN & BARRIER	
NA	EXISTING TREE	
とう、ま	TO BE RETAINED	
_KUKII'z		
	EXISTING TREE	
*400 EST.	TO BE REMOVED	
A	PERMANENT SURVEY MARK	
,	TEMPORARY BENCH MARK	
	PROPOSED DRIVEWAY & FOOTPATH	
	PROPOSED INDUSTRIAL DRIVEWAY	
	PROPOSED SHARED FOOTPATH	
	PROPOSED SHARED FOOTPATH PROPOSED ROAD PAVING	

LEGEND - LAYOUT PLAN

WARNING BEWARE OF UNDERGROUND SERVICES

SHEET No. REVISION 4

The locations of underground services are approximate only and their exact position should be proven on site.

No guarantee is given that all existing services are shown.

Locate all underground services before commencement of works

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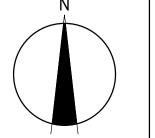
85-109 Farm Road - Stage 2B Wyndham City Council Road and Drainage Layout Plan

MELWAYS REF PROJECT / DRAWING No. 205 G12 2053E-02B-02

NAME					
H.Ehsani					
N.Green					
L.Veiyra					(
L.Vieyra	0	5	10	20	
					· \

Scale 1:500

SCALE AS SHOWN AT A1







AMENDMENT / REVISION DESCRIPTION

ISSUED TO COUNCIL FOR APPROVAL

ISSUED FOR CONSTRUCTION

DATE

13.04.21

11.02.22

DES/DFT

NG/SS

LV/JD

APPROVAL

LV

LV

All setting out should be carried out in accordance with MPA/Council's

DRAFTER

DESIGNER

CHECKED


AUTHORISED

REFERENCE No. 1

standard drawings or as nominated on hard copy plans provided by

SMEC. Any digital information supplied by this office is for information

only. Any discrepancies should be discussed with the superintendent.

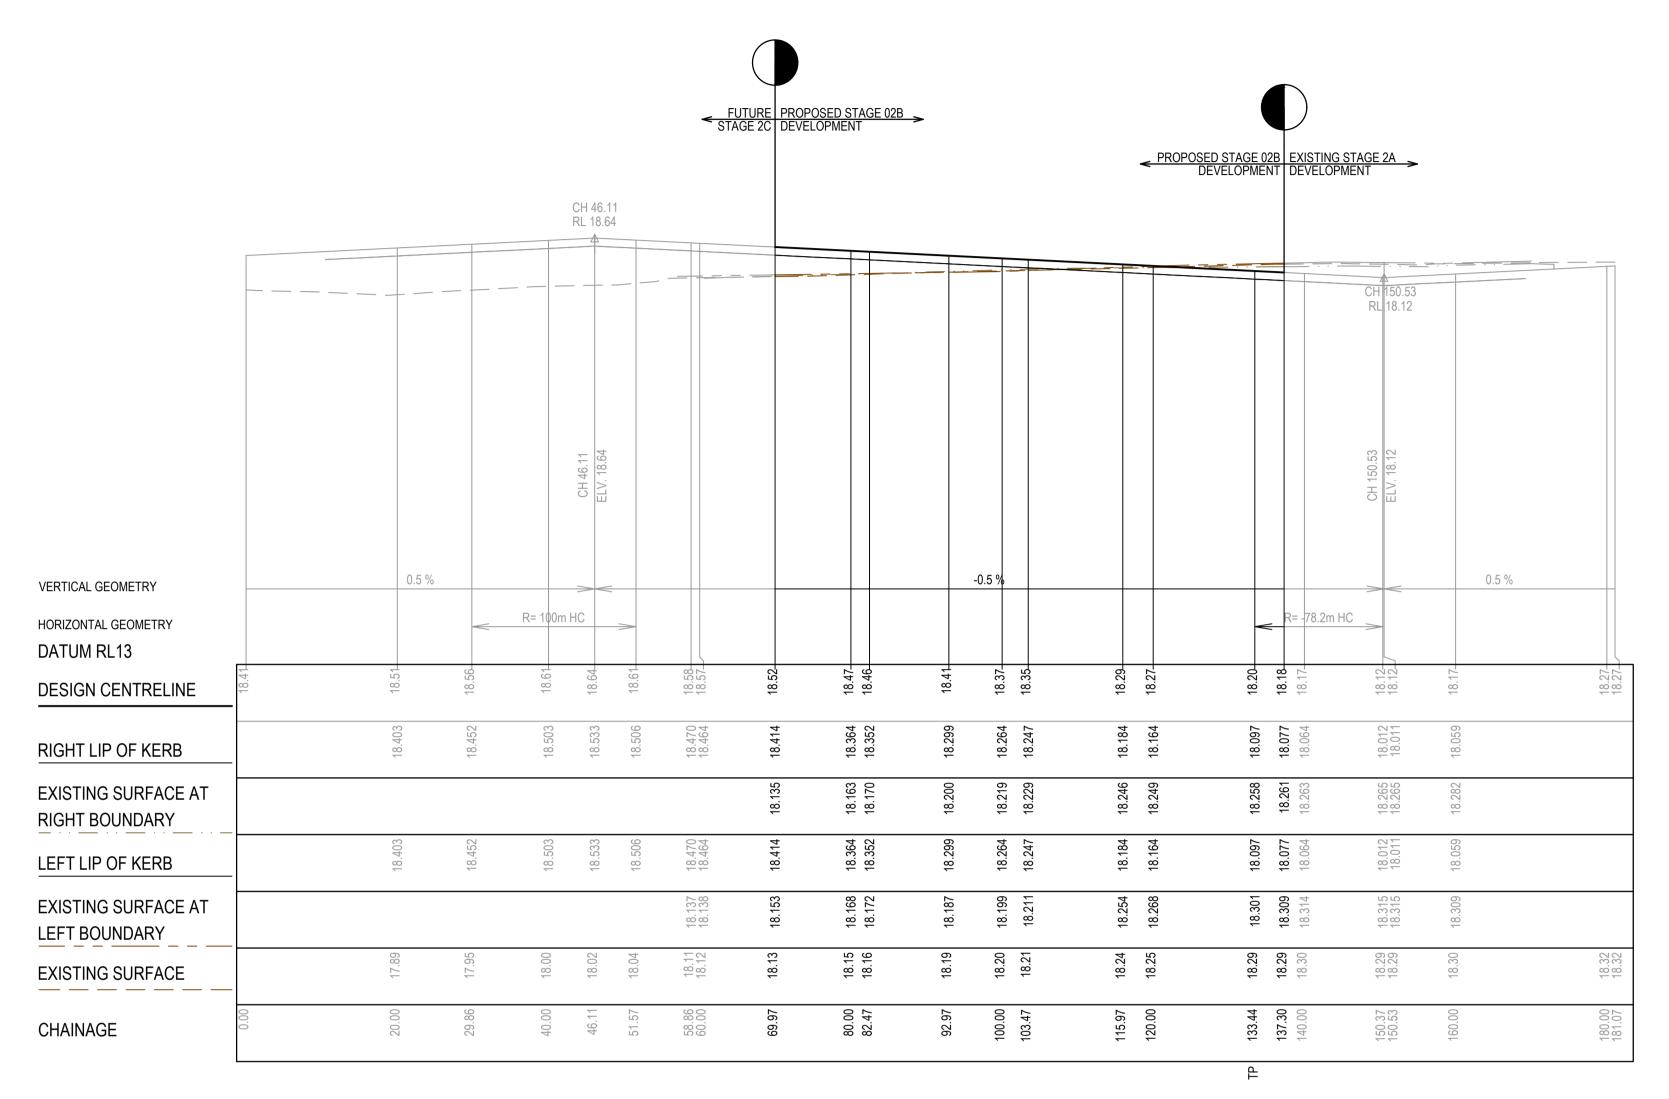

HANLON STREET LONGITUDINAL SECTION

AS CONSTRUCTED PLANS

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ISSUED FOR CONSTRUCTION

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DESIG




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by ation	DRAFTER	H.Ehsani
lent.	DESIGNER	N.Green
nent	CHECKED	L.Veiyra
15014007	AUTHORISED	L.Vieyra
4007	REFERENCE No. 1	
m.au®	REFERENCE No. 2	
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NAME

0 5 10 20 0 0.5 1 2 Scale H1:500, V1:50 SCALE AS SHOWN AT A1




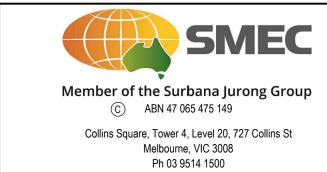


85-109 Farm Road - Stage 2B
Wyndham City Council
Road and Drainage
Longitudinal Sections

MELWAYS REF PROJECT / DRAWING No. 205 G12 2053E-02B-03

8-03 SHEET No. REVISION 1

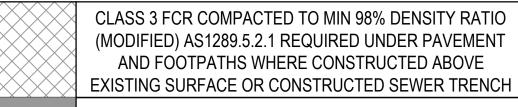

TOP SOIL AS PER COUNCIL SPECIFICATIONS

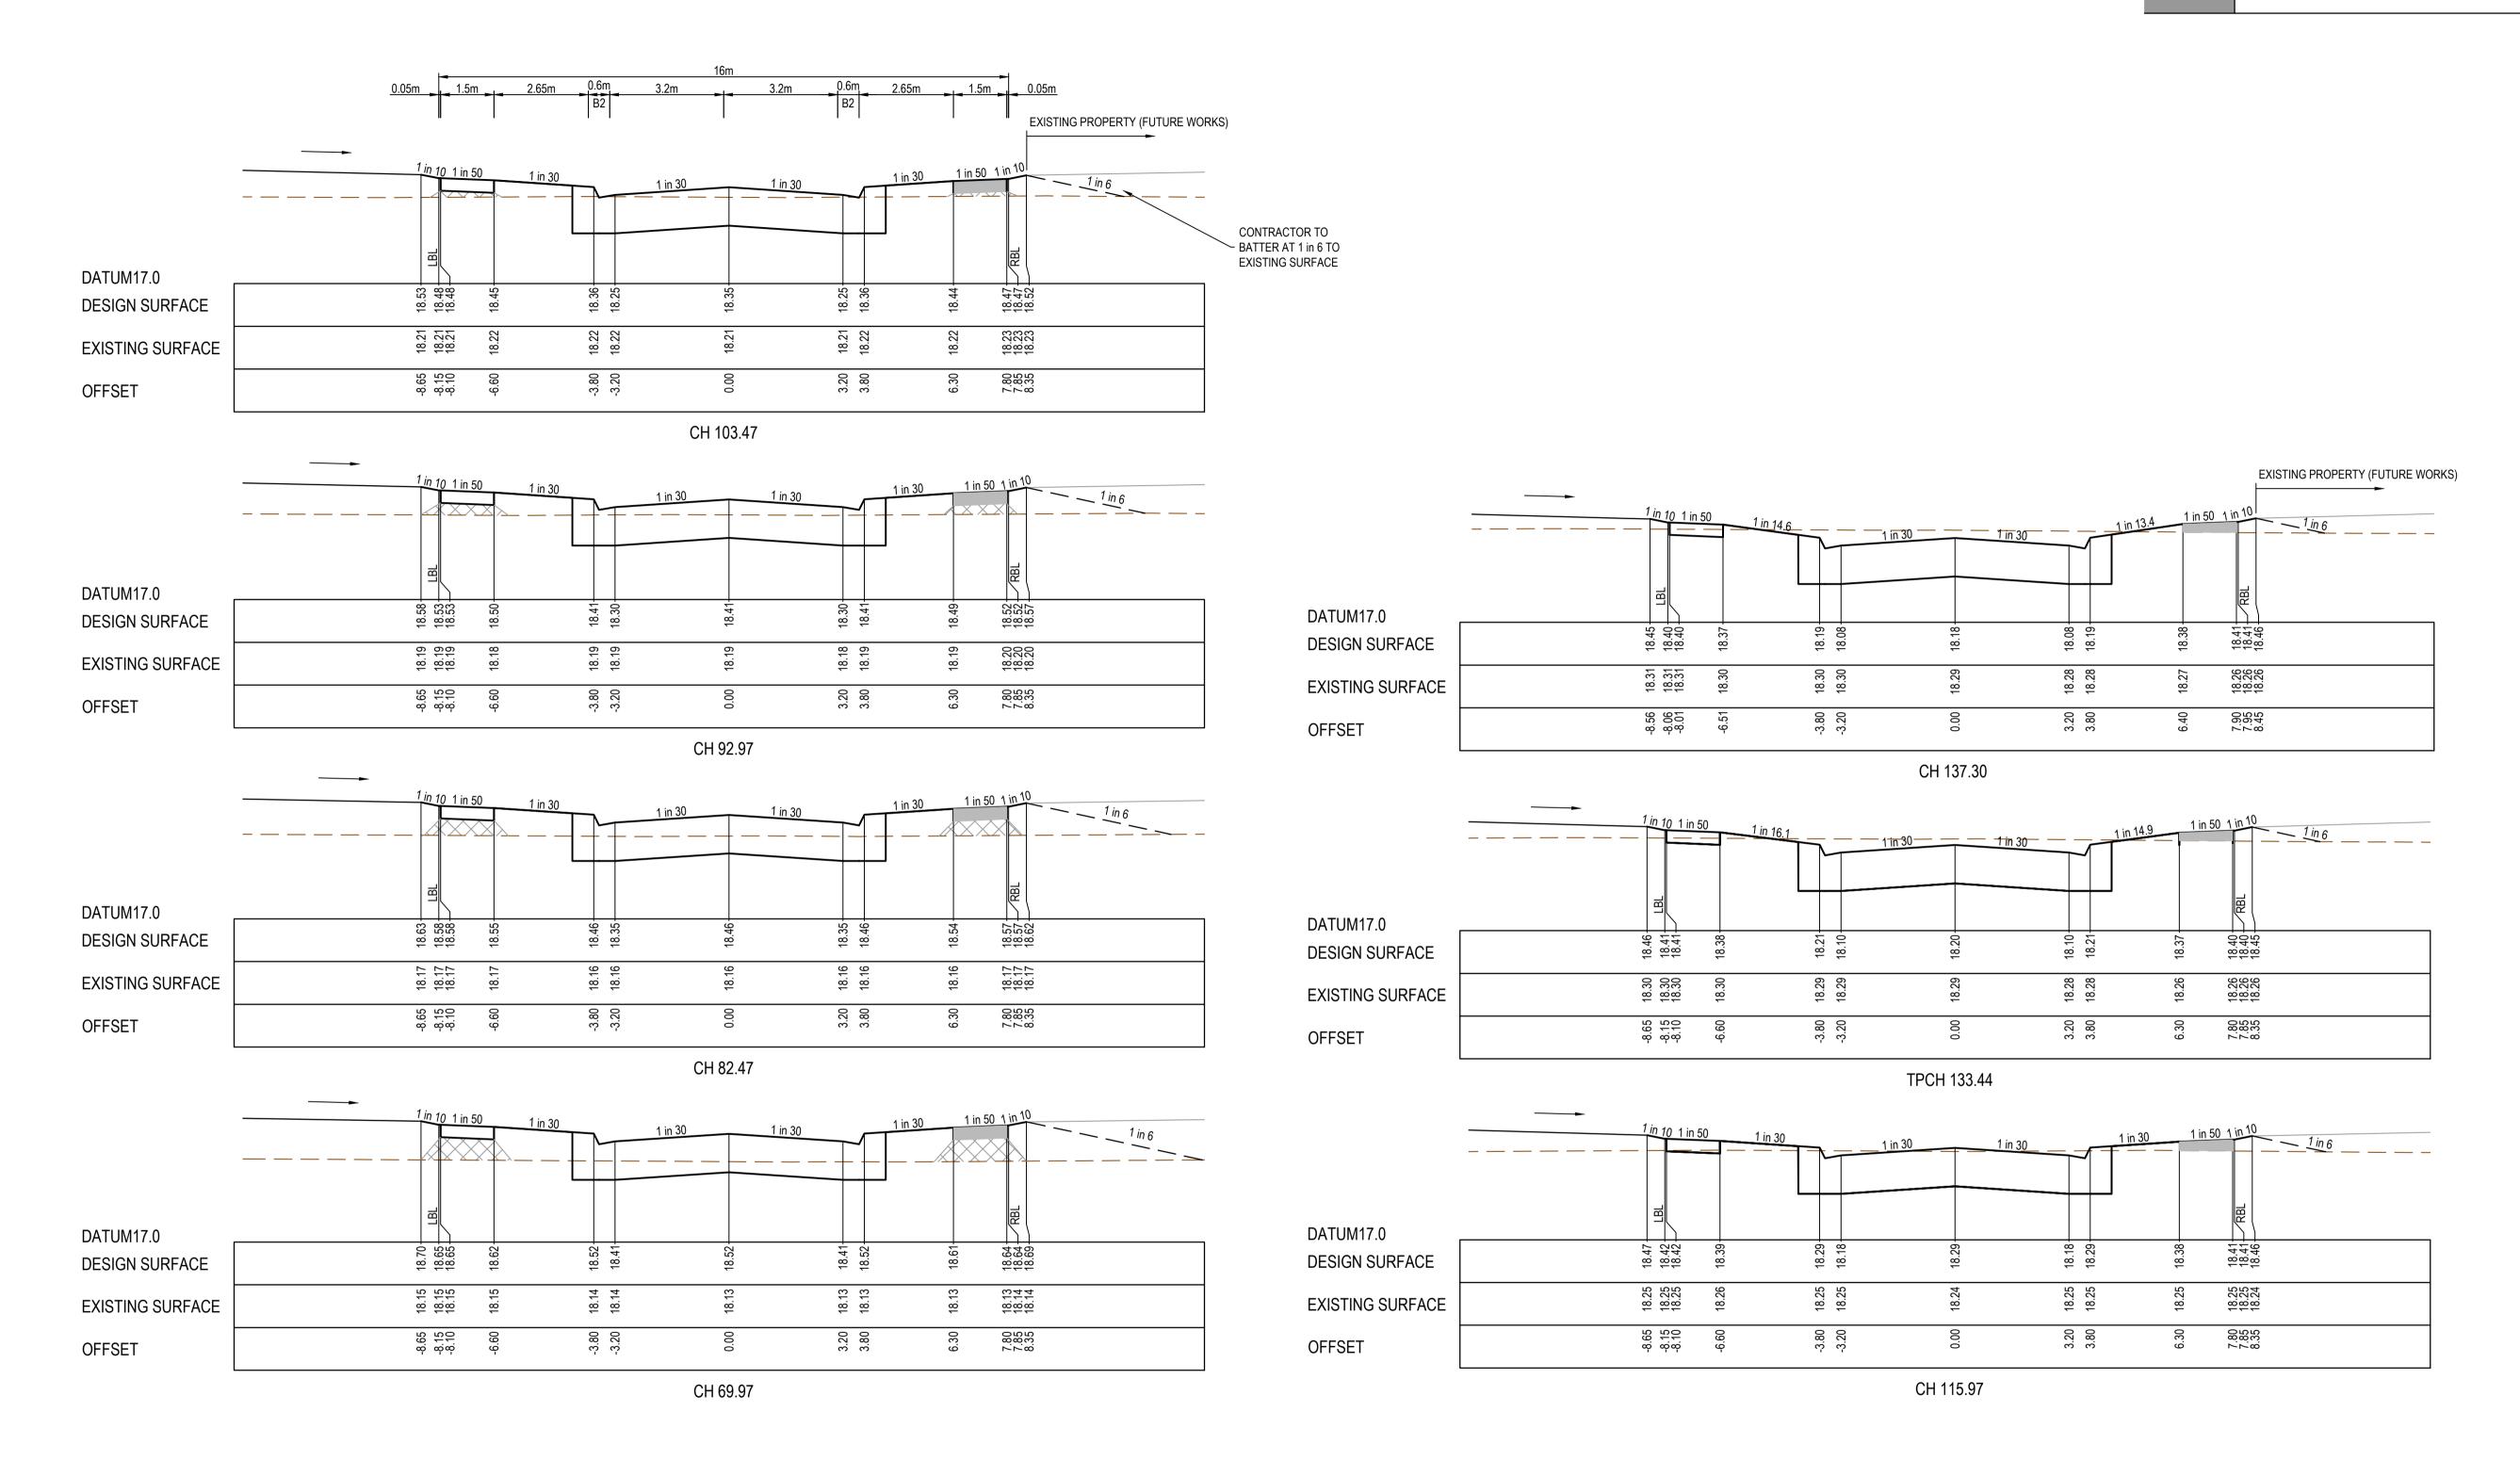

AS CONSTRUCTED PLANS


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ISSUED FOR CONSTRUCTION


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NAME






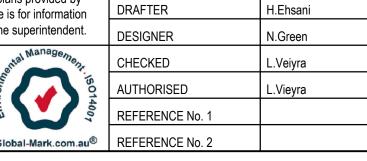

85-109 Farm Road - Stage 2B
Wyndham City Council
Road and Drainage
Road Cross Section From CH:69.98 to 137.29

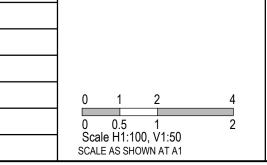MELWAYS REF PROJECT / DRAWING No. 205 G12 2053E-02B-04

SHEET No. REVISION 2

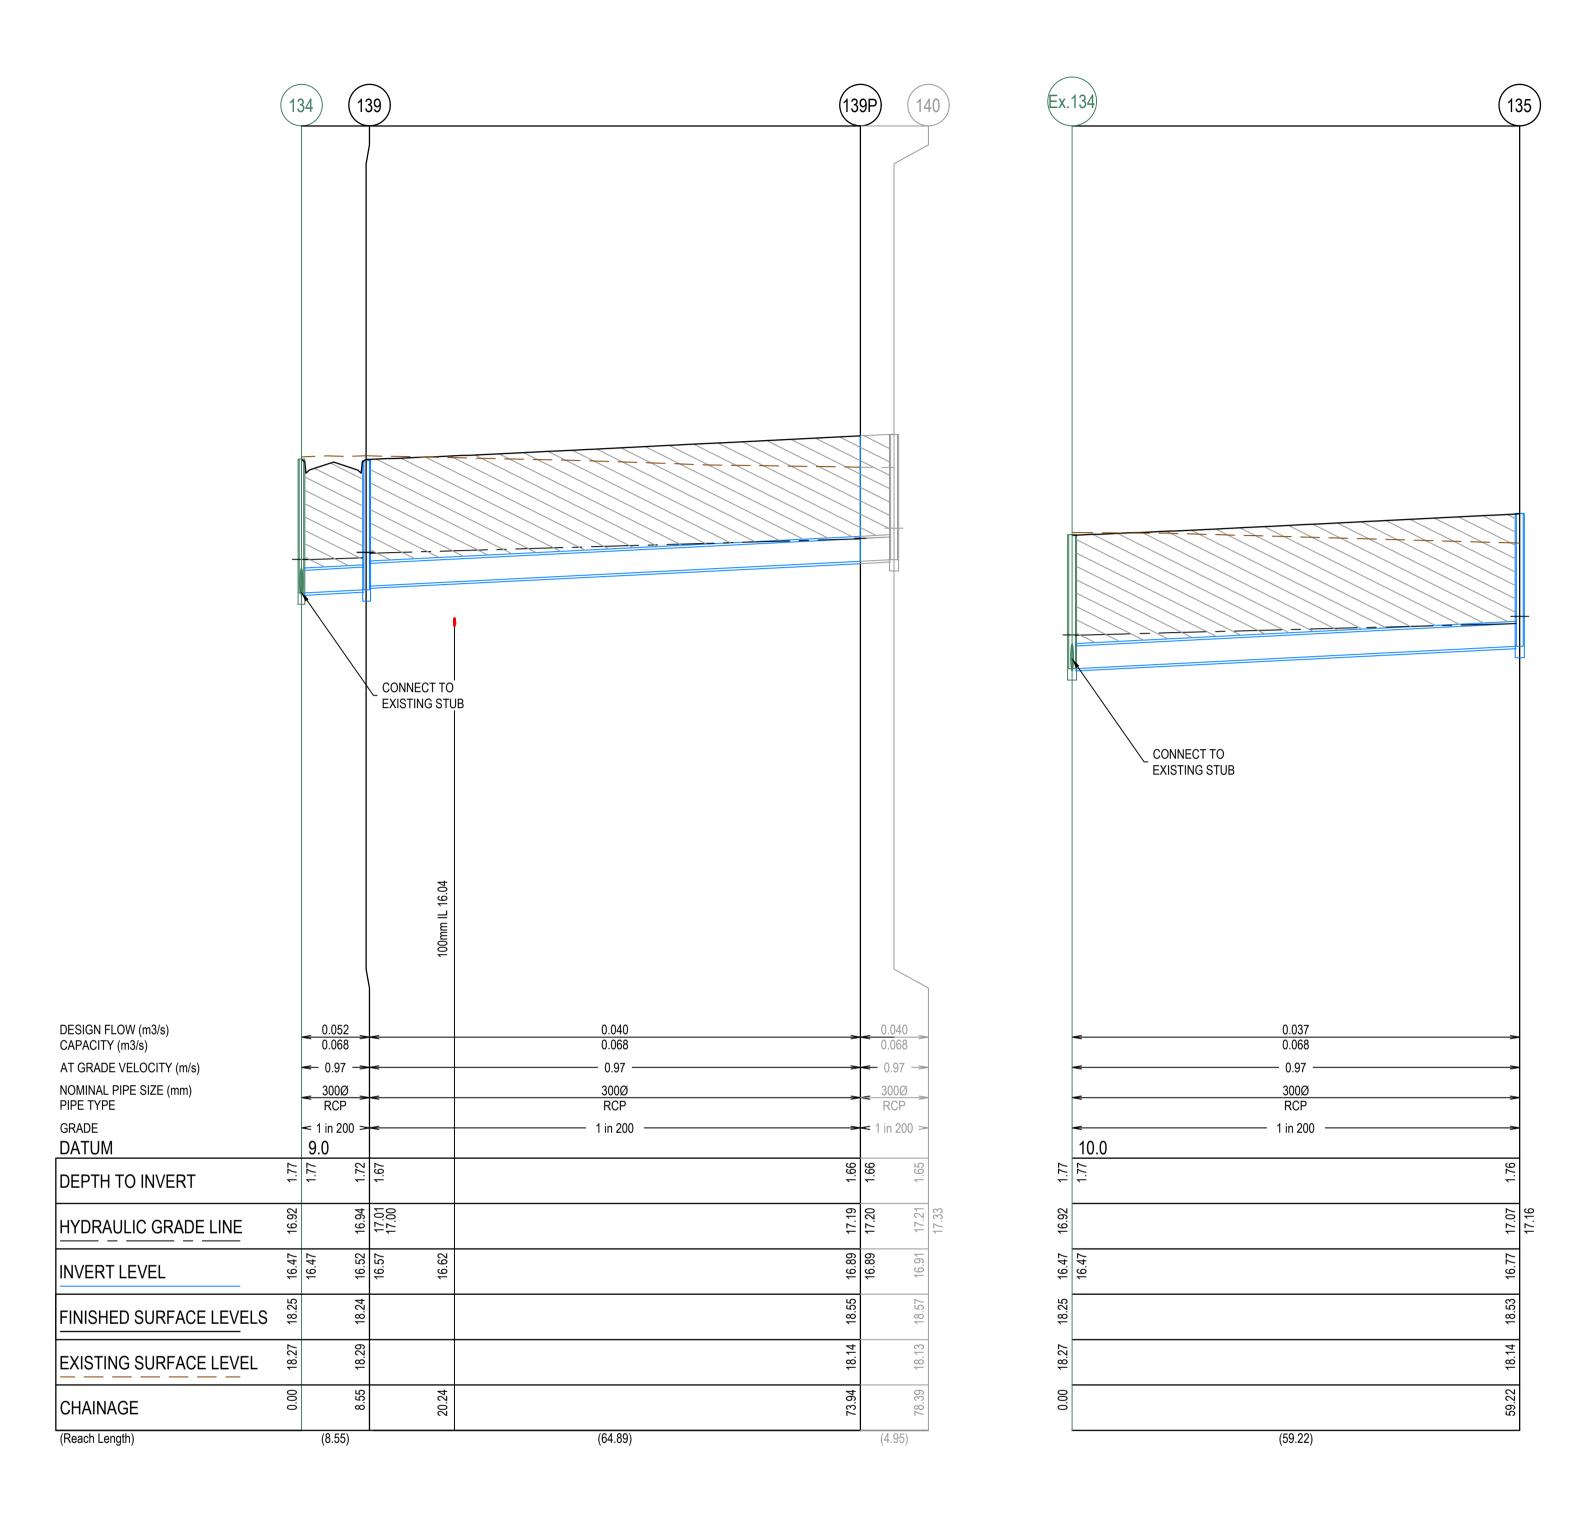

	PIT SCHEDULE										
PIT NUMBER	TYPE	INTE	RNAL	INI	_ET	OUT	LET	F.S.L. (m)	DEPTH (m)	CTANDADD DDAWING	REMARKS
PIT NUMBER	ITPE	WIDTH (mm)	LENGTH (mm)	DIAMETER (mm)	INVERT R.L. (m)	DIAMETER (mm)	INVERT R.L. (m)			STANDARD DRAWING	REWARKS
Ex.134	SINGLE SIDE ENTRY PIT	600	900	300	16.473	375	16.423	18.246	1.823	EDCM 601	CONVERT TO SEP AND ADJUST COVER LEVELS AS REQUIRED. CONNECT TO EXSITING STUBS AT IL16.47 IN BOTH NORTH AND SOUTH WALLS
				300	16.473						
139	GRATED SIDE ENTRY PIT	600	900	300	16.566	300	16.516	18.229	1.714	EDCM 601	
139P	ENDPIPE			300	16.89	300	16.89	18.544	1.654		CAP ENDPIPE FOR FUTURE CONNECTION
135	GRATED SIDE ENTRY PIT	600	900			300	16.769	18.526	1.757	EDCM 601	

AS CONSTRUCTED PLANS

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ISSUED FOR CONSTRUCTION

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SMEC. Any digital info	rmation supplied by this of	ffice is for information	
•	as nominated on hard cop	, , ,	
•	e carried out in accordance		



ice is for information	DRAFTER	H.Ehsani
the superintendent.	DESIGNER	N.Green
antal Management	CHECKED	L.Veiyra
Management, 15014007	AUTHORISED	L.Vieyra
4007	REFERENCE No. 1	
Global-Mark.com.au®	REFERENCE No. 2	

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0 0.5 Scale H1:500,		2	
SCALE AS SHOW	N AT A1		_





85-109 Farm Road - Stage 2B
Wyndham City Council
Road and Drainage
Drainage Longitudinal Section and Pit schedule

MELWAYS REF PROJECT / DRAWING No. 205 G12 2053E-02B-05




NOTE

ALL PAVEMENT DESIGNS HAVE BEEN PROVIDED BY GROUND SCIENCE. SMEC IS NOT RESPONSIBLE FOR GEOTECHNICAL OR PAVEMENT RELATED DESIGNS AND IS NOT RESPONSIBLE FOR THE ACCURACY, ADEQUACY OR APPROPRIATENESS OF THESE DESIGNS. THE PAVEMENT COMPOSITIONS SHOWN ON THIS DRAWING HAVE BEEN REPRODUCED FROM THE PAVEMENT REPORT FOR THIS DEVELOPMENT STAGE. THIS DOCUMENT SHOULD BE REVIEWED BY THE CONTRACTOR TO ENSURE DESIGN HAS BEEN INTERPRETED CORRECTLY. A COPY OF THIS DOCUMENT WILL BE MADE AVAILABLE ON REQUEST. ANY DIFFERENCES FROM THIS REQUIREMENTS SHOWN ARE TO BE NOTIFIED TO THE SUPERINTENDENT BEFORE PROCEEDING.

2,000 VPD - CASSIDY ROAD PAVEMENT COMPOSITION					
540mm DEPTH PA	VEMENT COMPOSITION	LAYER			
PAVEMENT LAYER		THICKNESS (mm)	MATERIAL		
	WEARING COURSE	30	SIZE 10 TYPE N ASPHALT		
ASPHALT	BASE COURSE	30	SIZE 10 TYPE N ASPHALT		
	PRIME COAT	-	PRIMECOAT & 10mm SAMI		
BASE COURSE	BASE	130	SIZE 20 CLASS 2 CRUSHED ROCK		
SUBBASE COURSE	UPPER SUBBASE	200	SIZE 20 CLASS 3 CRUSHED ROCK		
CAPPING	CAPPING LAYER	150	TYPE A FILL (CBR => 8% SWELL <= 1.5% PERMEABILITY k < 1x10 ⁻⁹)		
CONSTRUCTION LAYER	CONSTRUCTION LAYER	150	TYPE A FILL (CBR => 8% SWELL <= 1.5% PERMEABILITY k < 1x10 ⁻⁹)		

ACCESS TRACK P.	AVEMENT COMPOSITION		
200mm DEPTH PA	VEMENT COMPOSITION	LAYER	
PAVE	MENT LAYER	THICKNESS (mm)	MATERIAL
ASPHALT	WEARING COURSE	30	SIZE 10 TYPE L ASPHALT
BASE COURSE	BASE	170	SIZE 20 CLASS 2 CRUSHED ROCK

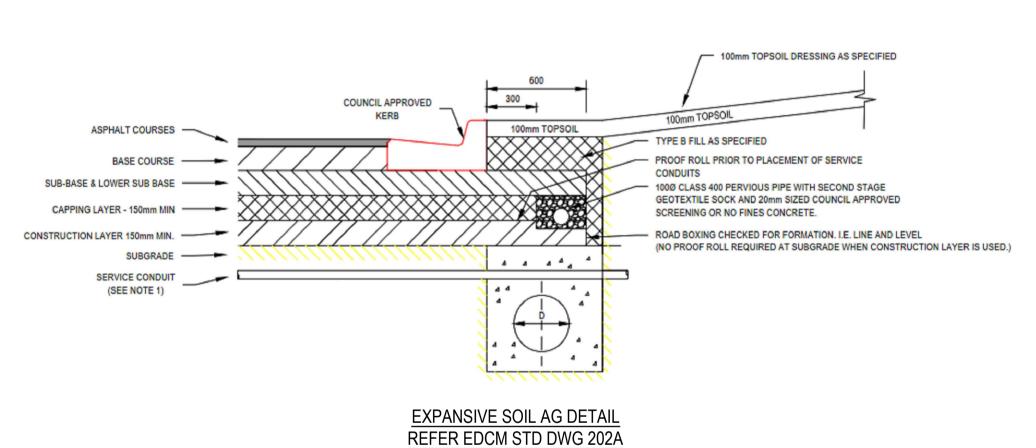

RRPMs TO BE IN ACCORDANCE WITH VICROADS

TRAFFIC ENGINEERING MANUAL MANUAL VOL 2. 2. ALL LINEMARKING & SIGNAGE TO BE IN ACCORDANCE WITH AUSTRALIAN STANDARD AS1742.

WARNING BEWARE OF UNDERGROUND SERVICES he locations of underground services are approximate only and

their exact position should be proven on site. No guarantee is given that all existing services are shown. Locate all underground services before commencement of works DIAL 1100 BEFORE YOU DIG www.1100.com.au

11.02.22 ISSUED TO COUNCIL FOR APPROVAL

13.04.21 ISSUED FOR CONSTRUCTION

AMENDMENT / REVISION DESCRIPTION

ISSUED FOR CONSTRUCTION

NG/SS


LV/JD

LV


All setting out should be carried out in accordance with MPA/Council's standard drawings or as nominated on hard copy plans provided by SMEC. Any digital information supplied by this office is for information only. Any discrepancies should be discussed with the superintendent.






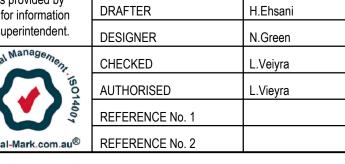

NAME

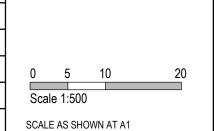

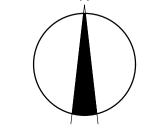



Ph 03 9514 1500




85-109 Farm Road - Stage 2B Wyndham City Council Road and Drainage Pavement Details

MELWAYS REF PROJECT / DRAWING No. 205 G12 2053E-02B-06


SHEET No. REVISION 3

<u>PHASE</u>	DISC	IPLINE CODE	RISK REGISTER -Construction POTENTIAL RISK	- Operations- Maintenance	RISK OWNER	POTENTIAL CONSEQUENCES	(Identify any Standard or Code of practice	HOW ISSUE ADDRESED IN DESIGN AND/OR CONSTRUCTION OF THE WORKS	IS THE RISK ELIMINATED YES/NO	"Residual Risk Likelihood (0-5)"	"Residual Risk Consequence (0-5)"	"Residual Risk Rating"	RESIDUAL RISK OWNER
			Road Furniture / Roadside features										
Construction	RD	Roads	Construction close to live traffic	New works will be constructed adjacent to live traffic when abutting existing stages.	Contractor	Disruptions to live traffic, construction incident involving live traffic.	Provide safe temporary traffic control (TCP)	TCP provided within contract	N	5.000	3.000	15.000	Constructor
Construction	US	Utilities or Services	Utilities become a hazard within clear zones	Vehicle conflict with utility / pit	Contractor	Personal injury, vehicle damage	Sequence works and protect with temp barrier or traffic control (TCP)	TCP provided within contract	N	1.000	5.000	5.000	Constructor
Operational	RD	Roads	Sight Lines	Inadequate drivers response time.	Road Authority	Increased potential for accidents	Ensure design complies with relevant standard. Undertake thorough Safety Audit	Vis lines checked and discussed with approval authority as part of design approval process	N	1.000	4.000	4.000	Road Authority
Operational	LS	Lines and Signs	Signs and street lights	Potential for drivers / riders to strike signs and street lights	Road Authority	Increased potential for accidents	Ensure design complies with relevant standard. Undertake thorough Safety Audit	Refer to appropriate standard for sign and lighting offsets	N	1.000	4.000	4.000	Road Authority
			Drainage										
Operational	DR	Drainage	Grated Pits	Trip/fall hazard with large spaced grate	Relevant Authority	Increased potential for accidents		Design in accordance with authority and manufacturers standards	N	3.00	2.00	6.00	Authority
Maintenance	DR	Drainage	Access to Pits	Lack of safe access for maintenance	Relevant Authority	Increased risk to maintenance crews	Provide safe working conditions for maintenance. Provide safe landing/ access arrangements as per relevant authority standards	Where possible design pit in location for easy access and outside of permanent water bodies	N	2.00	5.00	10.00	Authority
Maintenance	DR	Drainage	Access to drains / culverts	Lack of safe access for maintenance	Relevant Authority	Increased risk to maintenance crews	Provide safe working conditions for maintenance. Access as approved by authority	Design pit in location for easy access as agreed with authority	N	2.00	3.00	6.00	
			Sewer										
Construction	SE	Sewer	Sewer Manhole located adjacent to Retaining Wall Alignment	Falling from height during construction or commissioning of adjacent sewer manholes	Contractor	Falling from a height	Provide temporary fencing until such time that permanent fencing is constructed	Provide fencing (at heights) during design process	N	1.00	1.00	1.00	Constructor
Maintenance	SE	Sewer	Access to Manholes	Lack of safe access for maintenance	Relevant Authority	Increased risk to maintenance crews	Provide safe working conditions for maintenance. Manholes located in compliance with authority standards	Where possible design manhole in location for easy access	N	1.00	5.00	5.00	Authority
Maintenance	SE	Sewer	Pump Station Access	Lack of safe access for maintenance	Relevant Authority	Increased risk to maintenance crews	Provide safe working conditions for maintenance	Design pump station in location for easy access	N	2.00	4.00	8.00	Authority
			Electricity										
Operational	ES	Electrical Services	Electrical Design	Location of assets within clear zones e.g., pits/substations	Relevant Authority	Increased potential for accidents	Electrical designed by sub consultant with appropriate	Pits designed below ground. Where above ground adequate offset from vehicle clear zones has been provided or barrier protection provided	N	2.00	3.00	6.00	Authority
			Telstra										
Operational	TE	Telstra	Telstra Design	Location of assets within clear zones e.g., pits	Relevant Authority	Increased potential for accidents	appropriate accreditation and in accordance with authority	Pits designed below ground. Where above ground adequate offset from vehicle clear zones has been provided or barrier protection provided	N	2.00	3.00	6.00	Authority
			Water										
Operational	WA	Water	Water Design	Location of assets within clear zones e.g pits/ substations	Relevant Authority	Increased potential for accidents	Water pits designed in accordance with authority standards	Pits designed below ground. Where above ground adequate offset from vehicle clear zones has been provided or barrier protection provided	N	2.00	3.00	6.00	Authority
			Gas										
Operational	GA	Gas	Gas Design	Location of assets within clear zones e.g., pits/substations	Relevant Authority	Increased potential for accidents	Water pits designed in accordance with authority standards	Pits designed below ground. Where above ground adequate offset from vehicle clear zones has been provided or barrier protection provided	N	1.00	1.00	1.00	Authority

REV 0	DATE 13.04.21	AMENDMENT / REVISION DESCRIPTION ISSUED FOR CONSTRUCTION	DES/DFT NG/JD	APPROVAL LV	All setting out should be carried out in accordar standard drawings or as nominated on hard or SMEC. Any digital information supplied by this only. Any discrepancies should be discussed w			
	IS	SUED FOR CONSTRUCT	ION		Wanagement GO 9001 SHO SHO			

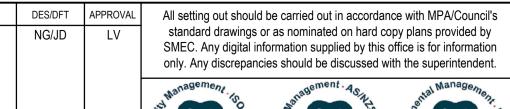



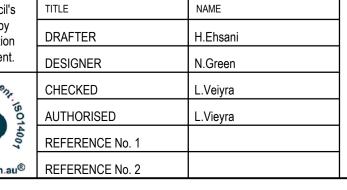

SCALE AS SHOWN AT A1



Collins Square, Tower 4, Level 20, 727 Collins St Melbourne, VIC 3008 Ph 03 9514 1500



85-109 Farm Road - Stage 2B Wyndham City Council Road and Drainage Safety In Design

MELWAYS REF PROJECT / DRAWING No. 205 G12 2053E-02B-85

SHEET No. REVISION 0