


85-109 Farm road Stage 03B

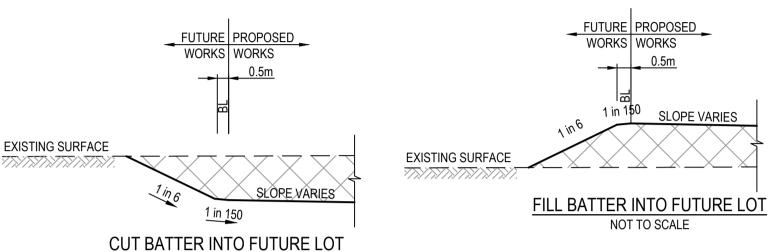

Drawing Index

2053E-03B-18 Signs & Linemarking Plan

2053E-03B-19 Pavement Details

2053E-03B-85 Safety In Design

2053E-03B-01 Cover Plan 2053E-03B-02 Layout Plan - 1 2053E-03B-03 Layout Plan - 2 2053E-03B-04 Earthwork Plan -2053E-03B-05 Earthwork Plan - 2 2053E-03B-06 Intersection Detail Plan 2053E-03B-07 Longitudinal Sections - 1 2053E-03B-08 Longitudinal Sections - 2 2053E-03B-09 Longitudinal Sections - 3 2053E-03B-10 Longitudinal Sections - 4 2053E-03B-11 Road Cross Section - 1 Jenkins Street CH14.90 - CH139.31 2053E-03B-12 Road Cross Section - 2 Jenkins Street CH153.31 - CH224.07 2053E-03B-13 Road Cross Section - 3 Lupton Street CH43.27 - CH120.21 2053E-03B-14 Road Cross Section - 4 Saddlebred Avenue CH86.42 - CH163.16 2053E-03B-15 Road Cross Section - 5 Yearling Promenade CH38.23 - CH127.52 2053E-03B-16 Drainage Longitudinal Section -2053E-03B-17 Drainage Longitudinal Section - 2

R15	110 40 450	- 15 CHAMFER
	600 600 B2 KERB DETAIL SCALE 1:10 EDCM	4 ,

NOT TO SCALE

-	LINE OF KERB
R15 R25	15 CHAMFER
200	
B1 KERB DET SCALE 1:10 EDCM	<u>AIL</u>

ROAD LAYOUT TABLE									
ROAD NAME	RESERVE	ROAD WIDTH (m)			KERB TYPE		VERGE WIDTH (m)		
	WIDTH (m)	LIP to LIP	INV to INV	BACK to BACK	NTH/WEST	STH/EAST	NTH/WEST	STH/EAST	
LUPTON STREET	16.00	6.40	7.30	7.60	600 B2	600 B2	4.35	4.05	
SADDLEBRED AVENUE	16.00	6.40	7.30	7.60	600 B2	600 B2	4.35	4.05	
JENKINS STREET	16.00	6.40	7.30	7.60	600 B2	600 B2	4.35	4.05	
VEARLING PROMENADE	14 50	6.40	7 30	760	600 B2	600 B2	4 35	2.55	

SERVICES OFFSET TABLE							
			RECYCLED WATER	ELECTRICITY	OPTIC FIBRE		
ROAD NAME	OFFSET (m)	OFFSET (m)	OFFSET (m)	OFFSET (m)	OFFSET (m)		
LUPTON STREET	2.10 W	3.10 W	2.60 W	2.50 E	1.85 E		
SADDLEBRED AVENUE	2.10 W	3.10 W	2.60 W	2.60 E	1.85 E		
JENKINS STREET	2.10 N	3.10 N	2.60 N	2.60 S	1.85 S		
YEARLING PROMENADE	2.10 W	3.10 W	2.60 W	1.10 E	0.30 E		

		TBM SETOUT TABLE		
POINT	EAST	NORTHING	ELEVATION	DESCRIPTION
C1RVTCT 1	311,726.94	5,818,242.85	44.23	RIVET IN CONCRETE
C1RVTCT 2	311,726.94	5,818,242.85	44.23	RIVET IN CONCRETE
C1RVTCT 3	311,726.94	5,818,242.85	44.23	RIVET IN CONCRETE
C1RVTCT 4	311,726.94	5,818,242.85	44.23	RIVET IN CONCRETE
C1RVTCT 5	311,726.94	5,818,242.85	44.23	RIVET IN CONCRETE
C1RVTCT 6	311,726.94	5,818,242.85	44.23	RIVET IN CONCRETE


YEARLING PROMENADE 14.50 | 6.40 | 7.30 | 760 | 600 B2 | 600 B2 | 4.35 | 2.55

IDM SEIOUI IABLE								
POINT	EAST	NORTHING	ELEVATION	DESCRIPTION				
C1RVTCT 1	311,726.94	5,818,242.85	44.23	RIVET IN CONCRETE				
C1RVTCT 2	311,726.94	5,818,242.85	44.23	RIVET IN CONCRETE				
C1RVTCT 3	311,726.94	5,818,242.85	44.23	RIVET IN CONCRETE				
C1RVTCT 4	311,726.94	5,818,242.85	44.23	RIVET IN CONCRETE				
C1RVTCT 5	311,726.94	5,818,242.85	44.23	RIVET IN CONCRETE				
C1RVTCT 6	311,726.94	5,818,242.85	44.23	RIVET IN CONCRETE				

ISSUED FOR CONSTRUCTION


AMENDMENT / REVISION DESCRIPTION


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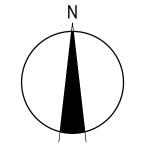


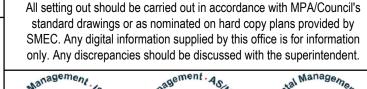





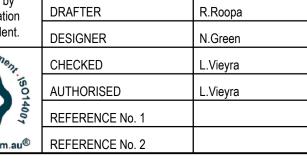

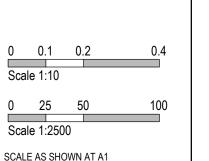







GENERAL NOTES (WYNDHAM CITY COUNCIL)

THE WORKS SHALL BE CONSTRUCTED IN ACCORDANCE WITH THE CURRENT EDCM ADDENDUM STANDARD DRAWINGS AND SPECIFICATIONS. WORKS TO BE CARRIED OUT TO THE SATISFACTION OF COUNCIL'S SUPERVISING

2. THE CONTRACTOR IS RESPONSIBLE FOR SAFETY OF WORK ON SITE IN ACCORDANCE WITH APPROPRIATE LEGISLATION. THE CONTRACTOR SHALL ERECT AND MAINTAIN ALL SHORING, PLANKING AND STRUTTING, DEWATERING DEVICES, BARRICADES, SIGNS, LIGHTS, ETC. NECESSARY TO KEEP WORKS IN A SAFE AND STABLE CONDITION, AND TO PROTECT THE PUBLIC FROM HAZARDS ASSOCIATED WITH THE WORKS.

COMPLY WITH THE SAFETY REQUIREMENTS OF THE MINES ACT, GENERAL REGULATIONS AND STATUTORY

RULES, AND THE MINES (TRENCHES) REGULATIONS 1982. NOTIFY THE OCCUPATIONAL HEALTH AND SAFETY AUTHORITY OF THEIR INTENTION TO COMMENCE TRENCHING

OPERATIONS WHERE TRENCHES ARE 1.5 METRES OR DEEPER. ENSURE THAT THE MINE MANAGER OR THEIR DEPUTY AS REQUIRED BY THE REGULATIONS IS IN ATTENDANCE WHEN TRENCHING OPERATIONS ARE IN PROGRESS.

4. THE CONTRACTOR IS TO NOTIFY COUNCIL AND ALL SERVICE AUTHORITIES SEVEN (7) DAYS PRIOR TO

COMMENCEMENT OF CONSTRUCTION. 5. THE LOCATION OF EXISTING SERVICES SHOULD BE DETERMINED BY THE CONTRACTOR PRIOR TO COMMENCING ANY EXCAVATION BY CONTACTING ALL RELEVENT SERVICE AUTHORITIES. ANY EXISTING SERVICES SHOWN ON THE

DRAWINGS ARE OFFERED AS A GUIDE ONLY AND ARE NOT GUARANTEED AS CORRECT. 6. TREES MARKED ON THE APPROVED PLANS FOR REMOVAL MUST BE REMOVED FROM THE SITE PRIOR TO THE COMMENCEMENT OF WORKS. NO EXCAVATION SHALL BE CARRIED OUT WITHIN 5.0m OF ANY EXISTING TREE UNTIL

APPROVAL HAS BEEN GIVEN BY COUNCIL'S SUPERVISING OFFICER. 7. ALL ROAD CHAINAGES ARE MEASURED ALONG THE ROAD CENTRELINE EXCEPT KERB RETURNS AND COURTHEADS, WHERE LIP OF KERB CHAINAGES ARE SPECIFIED. ALL DIMENSIONS AND RADII ARE GIVEN TO THE LIP OF KERB. DO

NOT SCALE OFF THESE DRAWINGS, WRITTEN DIMENSIONS ONLY SHALL BE USED. 8. CONDUIT LOCATIONS ARE SUBJECT TO AMENDMENT AND CONDUITS SHALL NOT BE LAID UNTIL WRITTEN APPROVAL IS GIVEN BY THE SUPERINTENDENT. BOTH KERBS ARE TO BE MARKED WITH THE LETTERS E,G,H,R,T&W ABOVE CONDUIT LOCATIONS AS SPECIFIED. RESPECTIVE LETTERS TO BE INDICATED ABOVE RELEVANT CONDUITS AS PER STANDARD DRAWING EDCM 303. CONDUITS TO BE PLACED MINIMUM OF 5m FROM BOUNDARIES WHERE POSSIBLE AND TO THE SATISFACTION OF THE SUPERINTENDENT IN ACCORDANCE WITH COUNCIL STANDARD DRAWINGS.

9. SUBSOIL DRAINS SHALL BE INSTALLED BEHIND OR BELOW ALL KERB AND CHANNEL AS PER STANDARD DRAWINGS EDCM 202 (EXPANSIVE SUBGRADE).

10. ALL LINEMARKING, SIGNING AND TRAFFIC CONTROL DEVICES TO BE IN ACCORDANCE WITH VICROADS REQUIREMENTS WITH LATERAL WORKS AND ARROWSBEING COLD APPLIED PLASTIC TROWELLED INTO PLACE (MATERIAL DEGAOUR OR PLASTELINE) AND LONGITUDINAL LINES BEING EXTRUDED THERMOPLASTIC MATERIAL (VICROADS SPECIFICATION SEE SECTION 710&722).

11. ALL LEVELS ARE TO AUSTRALIAN HEIGHT DATUM.

12. THE CONTRACTOR WHEN ENGAGED IN BLASTING OPERATION, SHALL NOT BLAST WITHIN 4.5m OF AN EXISTING LINE OF WATER, GAS OR SEWER PIPES OR WITHIN 15m OF ANY COMPLETED PART OF THE WORKS WITHOUT THE

13. ALL EXCAVATED OR FILLED AREAS OUTSIDE THE ROAD RESERVES SHALL BE SURFACED WITH A 100mm MINIMUM TO 200mm MAXIMUM LAYER OF TOPSOIL AS SPECIFIED. ALL FILLING ON ALLOTMENTS TO BE COMPACTED TO 95% STANDARD COMPACTION IN 150mm LAYERS AND AS PER THE SPECIFICATION. WHERE THERE IS FILL IN EXCESS OF 300mm IN DEPTH, THE CONTRACTOR IS TO CARRY OUT SOIL TESTS TO THE REQUIREMENTS OF APPENDIX B AS SPECIFIED IN THE AUSTRALIAN STANDARD AS 3798 TO SHOW THAT LEVEL 1 COMPACTION STANDARDS HAVE BEEN ACHIEVED. TEST RESULTS AND LOCATION OF TESTS FOR EACH ALLOTMENT SHALL BE APPROVED BY THE CONTRACTOR AND FORWARDED TO COUNCIL.

14. FILL MATERIAL USED UNDER PAVEMENTS AND FOOTPATHS MUST BE AN APPROVED MATERIAL TO THE STANDARD OF WYNDHAM CITY COUNCIL. ALL SUCH MATERIAL IS TO BE COMPACTED AS PER THE REQUIREMENTS OF THE SPECIFICATION APPROVED WITH THESE DRAWINGS PRIOR TO FORMWORK BEING PLACED. COMPACTION TESTS TO

BE COMPLETED AND PROVIDED TO SUPERINTENDENT. 15. FILL & CUT BATTERS ARE NOT TO EXCEED 1 in 6 SLOPE, UNLESS SHOWN OTHERWISE

16. ALL ALLOTMENTS SHALL BE SMOOTHED, GRADED AND SHAPED TO AN EVEN SURFACE WITH A MINIMUM FALL OF 1 in 150 TO THE DRAINAGE OUTLET SHOWN

17. ALL DRAINAGE PIPES ARE CLASS 2 RCP PIPES, RUBBER RING JOINTED UNLESS OTHERWISE SPECIFIED. 18. DRAINAGE PITS SHALL BE CAST MONOLITHICALLY. CEMENT RENDER SHALL ONLY BE USED TO REPAIR DEFECTS

19. BACKFILLING OF TRENCHES WHERE DRAINAGE AND SEWERAGE ARE IN CLOSE PROXIMITY ARE TO BE BACKFILLED AS PER WYNDHAM CITY COUNCIL STANDARD DRAWING SD6-10.

20. ALL SERVICING TRENCHES UNDER ROADS, FOOTPATHS, DRIVEWAYS, PARKING BAYS ETC. ARE TO BE BACKFILLED WITH CLASS 2 F.C.R.

21. ALL HOUSE DRAIN CONNECTIONS ARE TO BE LOCATED NO CLOSER THAN 5.00m FROM THE SIDE BOUNDARY. 22. INVERT OF PROPERTY INLETS TO BE 500mm MINIMUM BELOW FINISHED SURFACE UNLESS NOTED OTHERWISE

23. VEHICLE CROSSINGS TO BE CONSTRUCTED IN ACCORDANCE WITH STANDARD DRAWINGS EDCM 501 TO 503. DRIVEWAYS TO BE LOCATED MIN 0.75m FROM BUILDING LINE UNLESS SPECIFIED OTHERWISE AND CLEAR OF DRAINAGE PITS. SEWER MAINTENANCE HOLES AND EXISTING TREES. DOUBLE DRIVEWAY WIDTH TO BE 7.0m AT FRONT OF PATH/BUILDING LINE.

24. ADDITIONAL AND OVER-EXCAVATION SHALL BE BACKFILLED IN ACCORDANCE WITH THE PROVISIONS OF THE

25. FOOTPATH CROSSFALL TO BE 1:50

26. ALL FOOTPATHS AND SHARED PEDESTRIAN/BICYCLE PATHS ARE TO BE CONSTRUCTED AS PER CITY OF WYNDHAM SPECIFICATIONS AND MPA STANDARD DRAWINGS EDCM 401 TO 403.

27. ALL EXOTIC (NON NATIVE) TREES AND SHRUBS, INCLUDING DEAD TREES, NOT SHOWN ON THE DRAWINGS BUT LOCATED WITHIN THE WORKS ARE TO BE REMOVED AND DISPOSED OFFSITE

28. INSTALL BLUE RAISED REFLECTIVE PAVEMENT MARKER (BRRPM) ON ROAD CENTRELINE AND "GROUND BALL"

MARKER POST TO INDICATE LOCATION OF FIREPLUG. 29. THE CONTRACTOR IS TO ENSURE THAT THEIR CONSTRUCTION PROCEDURES AND STANDARDS CONTROL THE VOLUME AND LOCATION FOR COLLECTION OF SEDIMENT RUNOFF ACCORDING TO CURRENT EPA - ENVIRONMENTAL GUIDELINES FOR MAJOR CONSTRUCTION SITES.

30. UPON COMPLETION OF CONSTRUCTION THE WHOLE SITE SHALL BE CLEANED UP, GRADED AND ALL RUBBISH REMOVED. THE SITE IS TO BE LEFT IN A CLEAN AND TIDY CONDITION TO THE SATISFACTION OF THE

31. EXISTING PAVEMENT OR DRAINAGE WORKS DAMAGED DURING CONSTRUCTION OR THE MAINTENANCE PERIOD TO BE REINSTATED TO THE SATISFACTION OF THE COUNCIL ENGINEER.

32. THE LOWER SUB-BASE MATERIAL SHALL WILL BE N.D.C.R. FOR PAVEMENT MAKE UPS AS PER THE STANDARD DRAWINGS OF WYNDHAM CITY COUNCIL.

33. TOTAL LENGTH OF ROADS CONSTRUCTED IS 469.75m TOTAL LENGTH OF DRAINS CONSTRUCTED IS 316.62m

GAS - STANDARD NOTES

GAS MAINS, FITTINGS AND MARKER TAPE ARE TO BE SUPPLIED BY THE GAS AUTHORITY.

EXCAVATION, SUPPLY AND PLACEMENT OF REQUIRED BACKFILL TO BE UNDERTAKEN BY OTHERS. 3. NOTIFICATION MUST BE GIVEN TO THE GAS AUTHORITY TWO WEEKS PRIOR TO THE COMMENCEMENT OF

REINFORCED CONCRETE PIPE

WARNING

SAFETY MEASURES REQUIRED

1. ALL STORMWATER DRAINAGE PIPES SHALL NOT BE SUBJECTED TO CONSTRUCTION TRAFFIC LOADING DURING CONSTRUCTION UNLESS THE PIPE STRENGTH CHARACTERISTICS HAVE BEEN COMPUTED AND APPROVED BY THE

CONTRACTORS ENGINEER. COMPUTATIONS ARE TO ACCORD WITH AS.3725-2007, LOADS ON BURIED PIPES. 2. CONCRETE PIPES DAMAGED DUE TO CONSTRUCTION LOADS SHALL BE REPLACED & RELAID AT THE CONTRACTOR'S

WARNING


BEWARE OF UNDERGROUND SERVICES


The locations of underground services are approximate only and Please note there are risks attached to the construction o their exact position should be proven on site. this project, and any ongoing maintenance of structures. No guarantee is given that all existing services are shown. Consider the safety of all. For potential risks, consequence Locate all underground services before commencement of works and controls refer to Safety In Design Risk Register **DIAL 1100 BEFORE YOU DIG** SID P4.E6. 2053E-03B-85 ASSESS THE RISK - STAY SAFE www.1100.com.au


> 85-109 Farm road - Stage 3B Wyndham City Council Road and Drainage Cover Plan

MELWAYS REF PROJECT / DRAWING No. 205 G12 2053E-03B-01

01 of 20

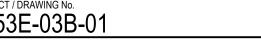

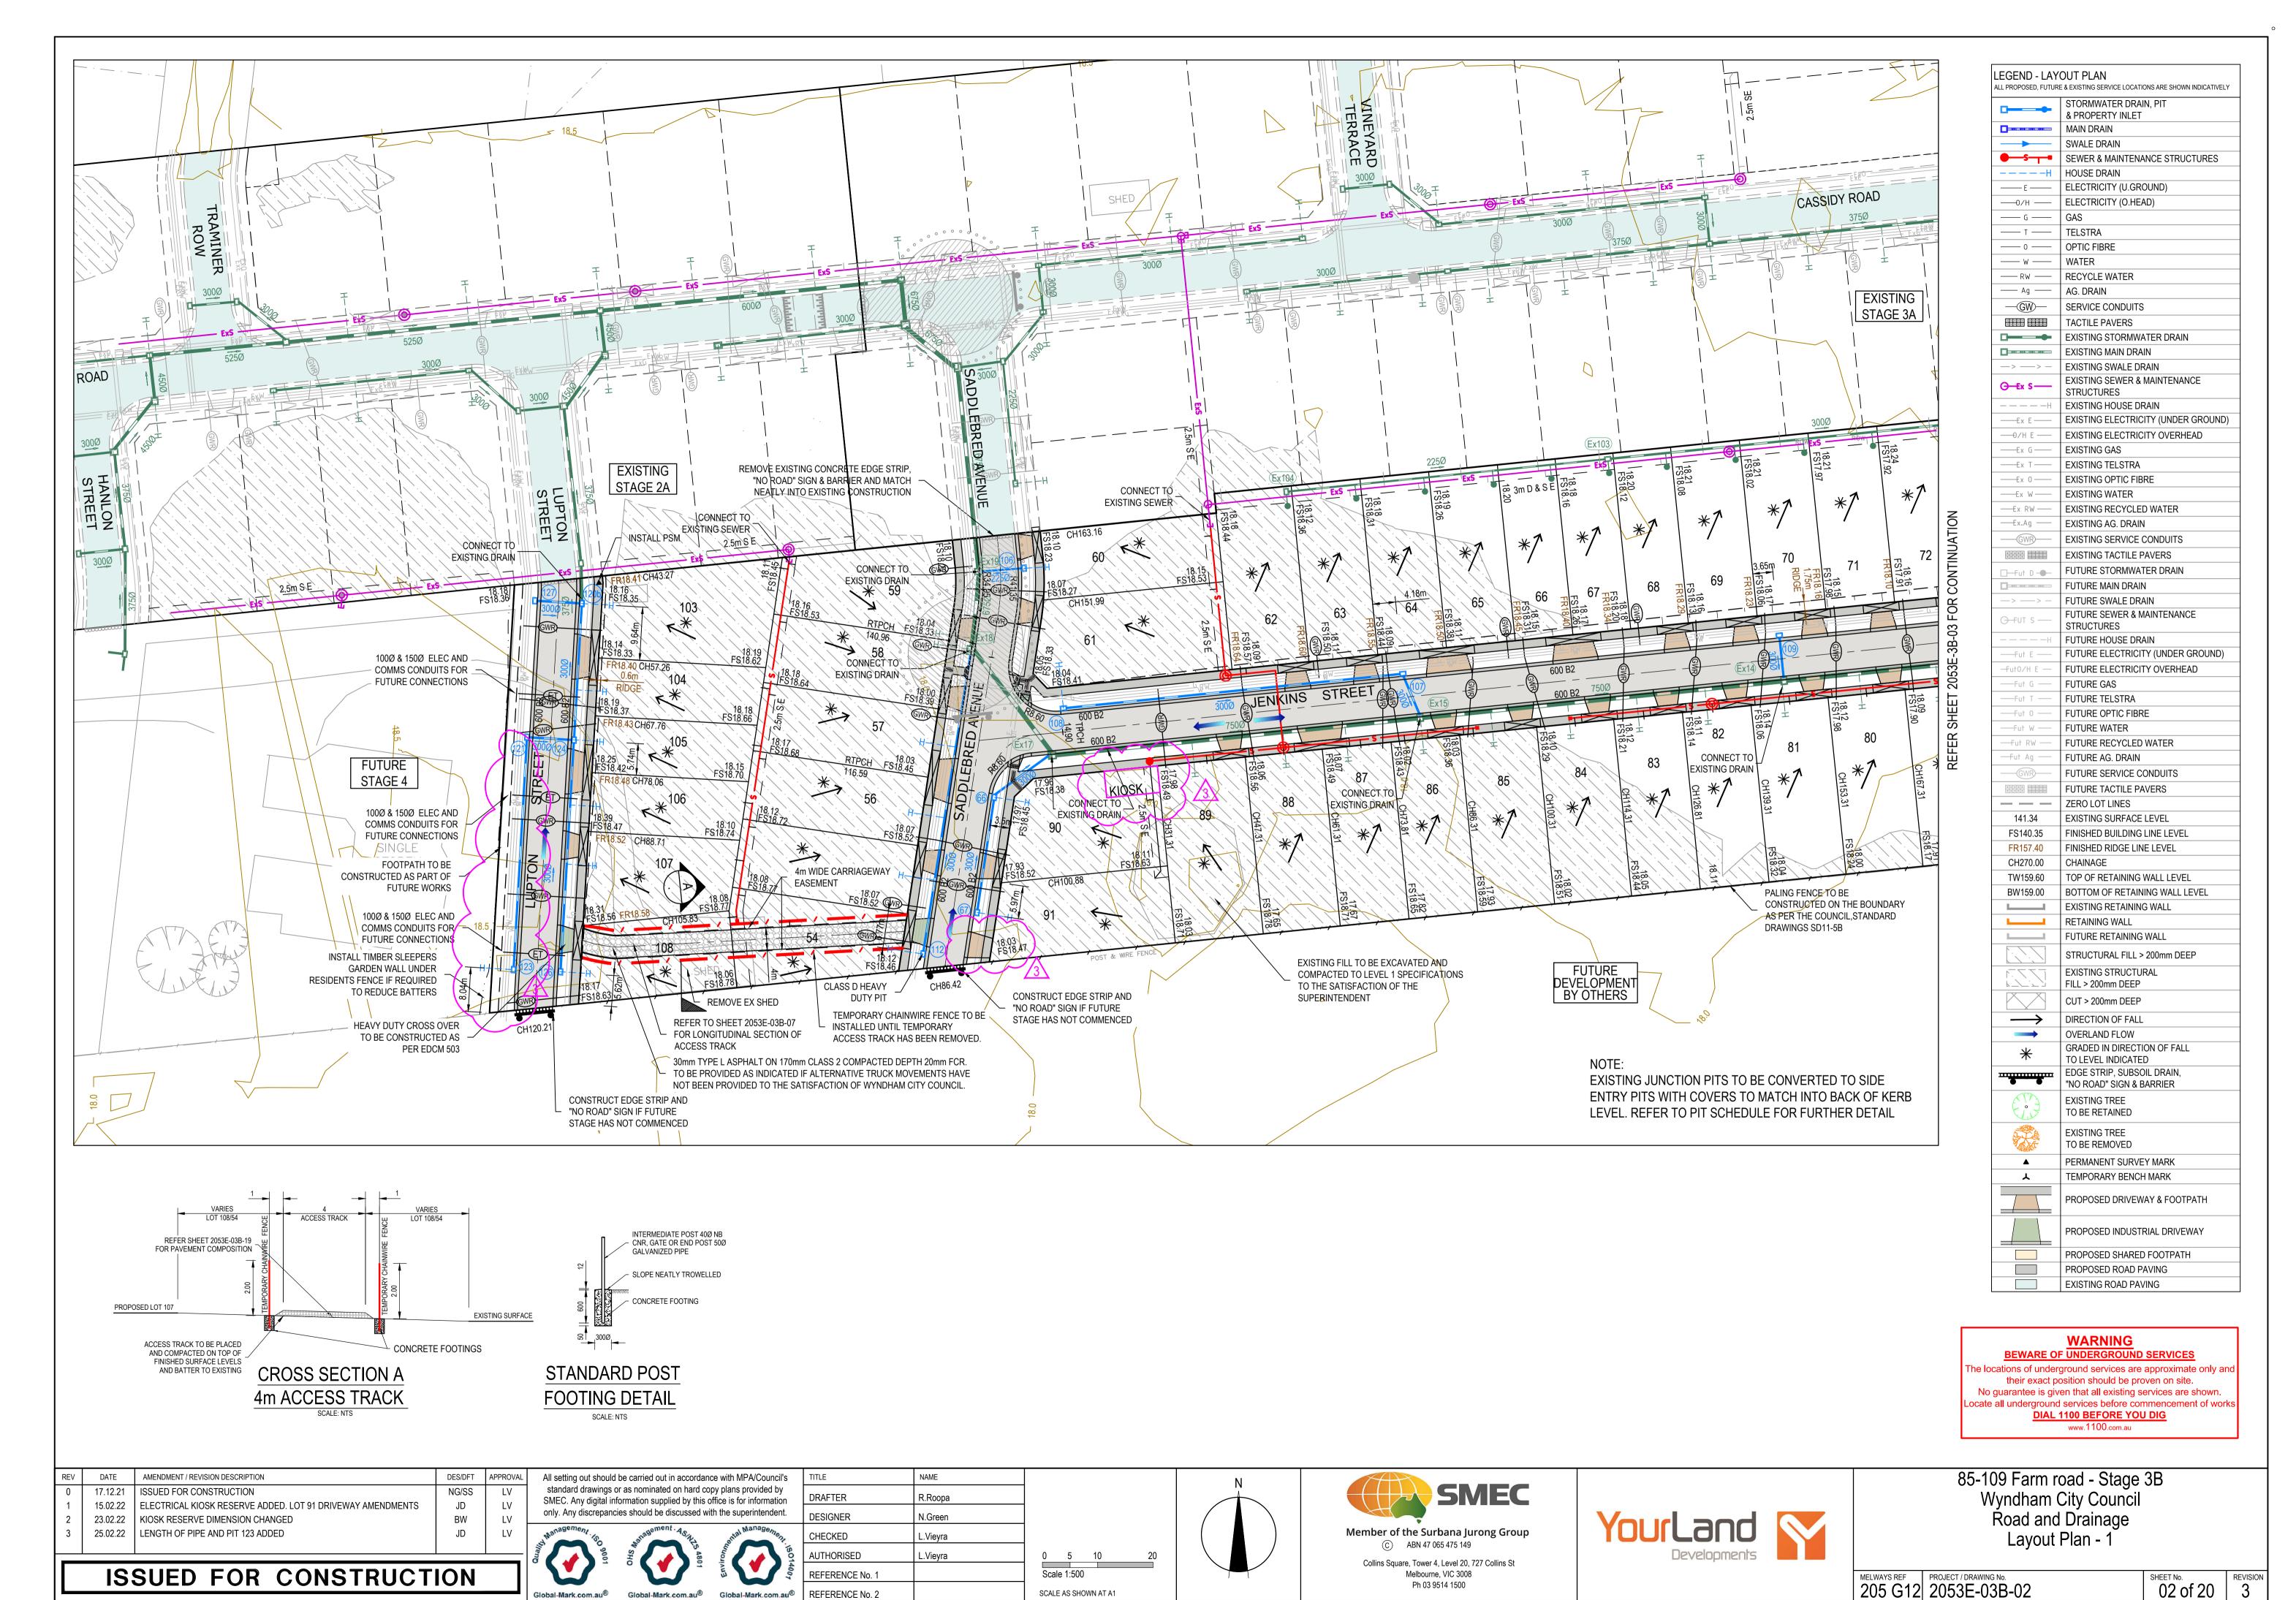

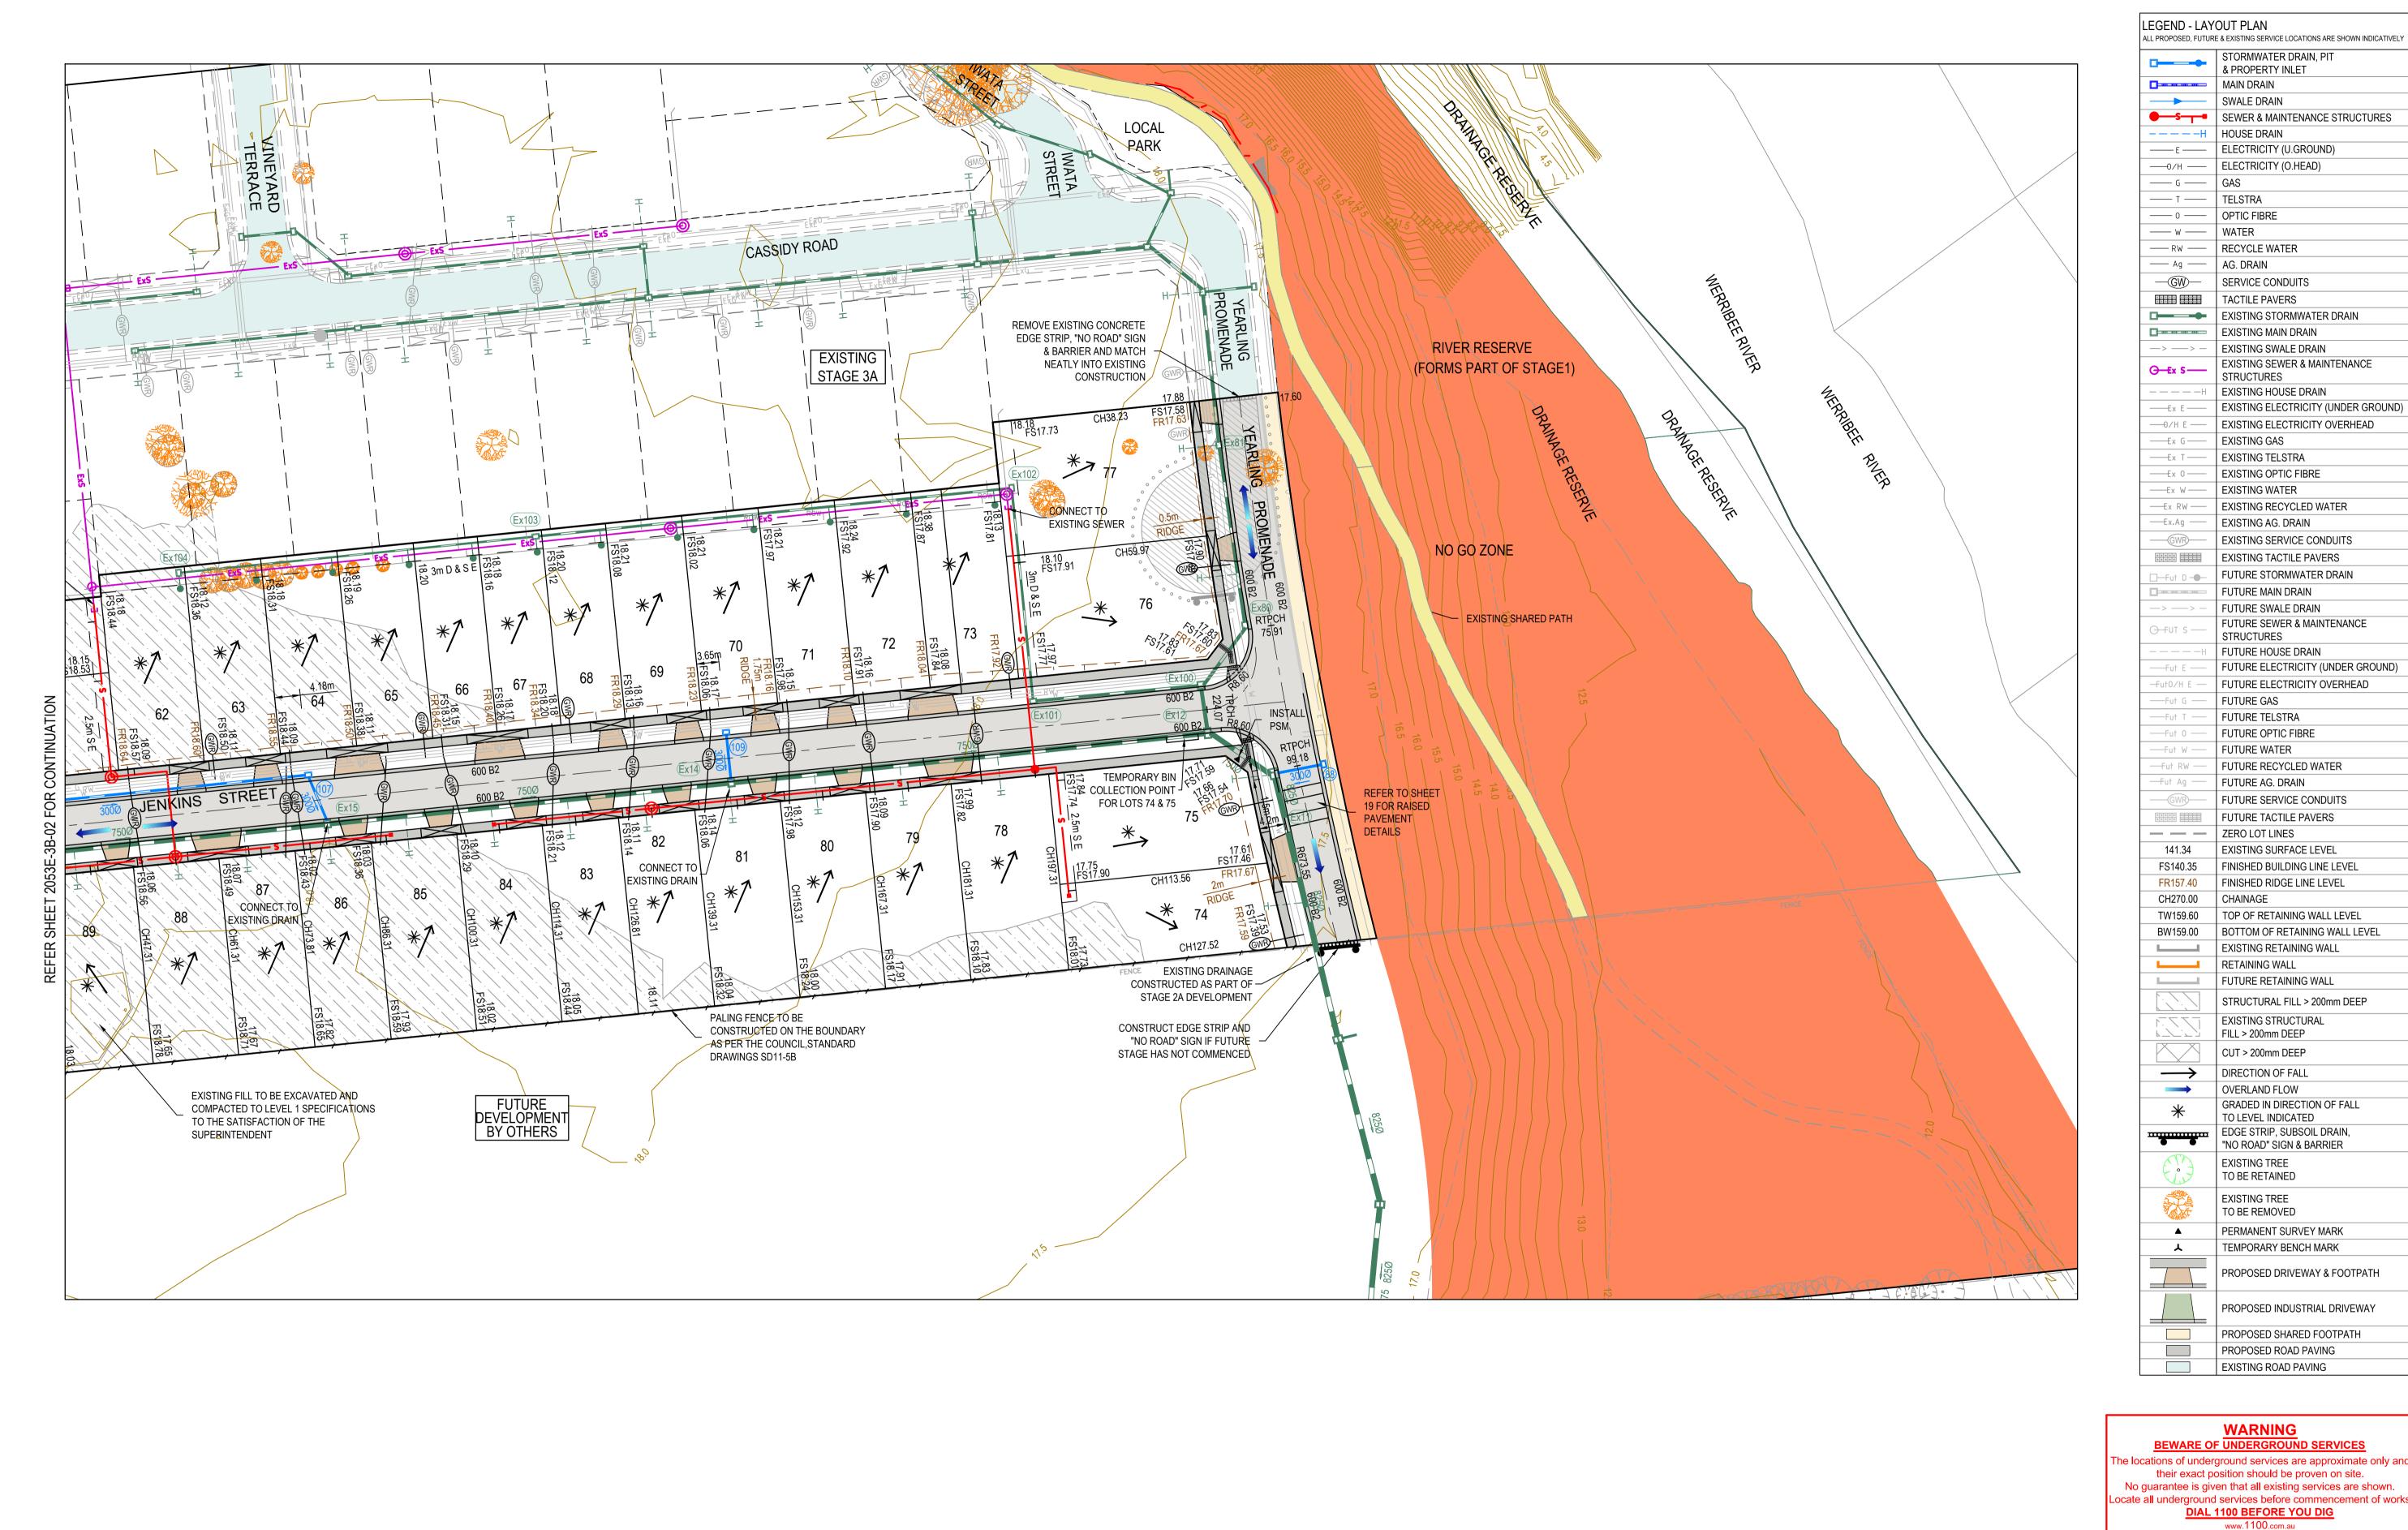

EXISTING TELSTRA EXISTING OPTIC FIBRE —Ex 0 — —Ex W — EXISTING WATER EXISTING RECYCLED WATER —Ex RW — —Ех.Ад — EXISTING AG. DRAIN EXISTING SERVICE CONDUITS EXISTING TACTILE PAVERS FUTURE STORMWATER DRAIN FUTURE MAIN DRAIN **FUTURE SWALE DRAIN** FUTURE SEWER & MAINTENANCE O-FUT S -STRUCTURES **FUTURE HOUSE DRAIN** FUTURE ELECTRICITY (UNDER GROUND) FUTURE ELECTRICITY OVERHEAD -FutO/H E -**FUTURE GAS** —Fut G − FUTURE TELSTRA —Fut T **FUTURE OPTIC FIBRE** ---Fut 0 -—Fut W — FUTURE WATER —Fut RW — FUTURE RECYCLED WATER —Fut Ag – FUTURE AG. DRAIN FUTURE SERVICE CONDUITS FUTURE TACTILE PAVERS ZERO LOT LINES - - -EXISTING SURFACE LEVEL 141.34 FS140.35 FINISHED BUILDING LINE LEVEL FINISHED RIDGE LINE LEVEL CH270.00 CHAINAGE TW159.60 | TOP OF RETAINING WALL LEVEL BOTTOM OF RETAINING WALL LEVEL **EXISTING RETAINING WALL** RETAINING WALL **FUTURE RETAINING WALL** STRUCTURAL FILL > 200mm DEEP EXISTING STRUCTURAL FILL > 200mm DEEP CUT > 200mm DEEP DIRECTION OF FALL OVERLAND FLOW GRADED IN DIRECTION OF FALL TO LEVEL INDICATED EDGE STRIP, SUBSOIL DRAIN, "NO ROAD" SIGN & BARRIER **EXISTING TREE** TO BE RETAINED EXISTING TREE TO BE REMOVED PERMANENT SURVEY MARK TEMPORARY BENCH MARK PROPOSED DRIVEWAY & FOOTPATH PROPOSED INDUSTRIAL DRIVEWAY PROPOSED SHARED FOOTPATH PROPOSED ROAD PAVING EXISTING ROAD PAVING WARNING
BEWARE OF UNDERGROUND SERVICES The locations of underground services are approximate only and their exact position should be proven on site. No guarantee is given that all existing services are shown. ocate all underground services before commencement of works **DIAL 1100 BEFORE YOU DIG** www.1100.com.au

STORMWATER DRAIN, PIT & PROPERTY INLET

ELECTRICITY (U.GROUND) ELECTRICITY (O.HEAD)

SEWER & MAINTENANCE STRUCTURES

MAIN DRAIN SWALE DRAIN

OPTIC FIBRE

RECYCLE WATER AG. DRAIN

SERVICE CONDUITS

EXISTING MAIN DRAIN

EXISTING SWALE DRAIN

EXISTING HOUSE DRAIN

EXISTING STORMWATER DRAIN

EXISTING SEWER & MAINTENANCE

EXISTING ELECTRICITY OVERHEAD

EXISTING ELECTRICITY (UNDER GROUND)

TACTILE PAVERS

STRUCTURES

EXISTING GAS

WATER

SUBJECT TO APPROVAL

PIT NO. ADDED, SHARED PATH SHOWN AS EXISTING

AMENDMENT / REVISION DESCRIPTION

30.04.21

17.06.21

ISSUED TO COUNCIL FOR APPROVAL

All setting out should be carried out in accordance with MPA/Council's standard drawings or as nominated on hard copy plans provided by SMEC. Any digital information supplied by this office is for information only. Any discrepancies should be discussed with the superintendent.


DES/DFT APPROVAL


LV

NG/SS

NG/SH

DRAFTER R.Roopa DESIGNER N.Green L.Vieyra AUTHORISED _.Vieyra REFERENCE No. 1

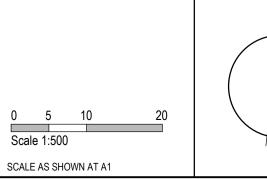

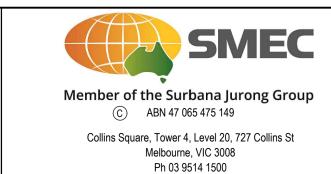



85-109 Farm road - Stage 3B Wyndham City Council Road and Drainage Layout Plan - 2

SHEET No. REVISION 0



STORMWATER DRAIN, PIT & PROPERTY INLET MAIN DRAIN SWALE DRAIN SEWER & MAINTENANCE STRUCTURES ELECTRICITY (U.GROUND) ELECTRICITY (O.HEAD) —0/H —— TELSTRA OPTIC FIBRE ----- w ----- | WATER RECYCLE WATER AG. DRAIN $-\overline{\text{GW}}$ SERVICE CONDUITS TACTILE PAVERS EXISTING STORMWATER DRAIN EXISTING MAIN DRAIN EXISTING SWALE DRAIN **EXISTING SEWER & MAINTENANCE ⊖**—Ex S—— STRUCTURES EXISTING HOUSE DRAIN EXISTING ELECTRICITY (UNDER GROUND) <u>—</u>Ех Е — —0/Н E — EXISTING ELECTRICITY OVERHEAD ——Ex G — **EXISTING GAS** —Ех Т — EXISTING TELSTRA —Ex 0 — EXISTING OPTIC FIBRE —Ex W — EXISTING WATER EXISTING RECYCLED WATER —E× RW — —Ех.Ад — EXISTING AG. DRAIN EXISTING SERVICE CONDUITS EXISTING TACTILE PAVERS FUTURE STORMWATER DRAIN **FUTURE MAIN DRAIN** FUTURE SWALE DRAIN FUTURE SEWER & MAINTENANCE O-FUT S -STRUCTURES FUTURE HOUSE DRAIN FUTURE ELECTRICITY (UNDER GROUND) —Fut E — FUTURE ELECTRICITY OVERHEAD -FutO/H E ---Fut G -**FUTURE GAS** ---Fut T **FUTURE TELSTRA** —Fut 0 -FUTURE OPTIC FIBRE —Fut W -**FUTURE WATER** —Fut RW -FUTURE RECYCLED WATER —Fut Ag -FUTURE AG. DRAIN FUTURE SERVICE CONDUITS FUTURE TACTILE PAVERS ZERO LOT LINES ____ EXISTING SURFACE LEVEL FS140.35 FINISHED BUILDING LINE LEVEL FR157.40 FINISHED RIDGE LINE LEVEL CH270.00 TOP OF RETAINING WALL LEVEL BOTTOM OF RETAINING WALL LEVEL BW159.00 **EXISTING RETAINING WALL** RETAINING WALL FUTURE RETAINING WALL STRUCTURAL FILL > 200mm DEEP **EXISTING STRUCTURAL** FILL > 200mm DEEP CUT > 200mm DEEP DIRECTION OF FALL OVERLAND FLOW GRADED IN DIRECTION OF FALL TO LEVEL INDICATED EDGE STRIP, SUBSOIL DRAIN, "NO ROAD" SIGN & BARRIER EXISTING TREE TO BE RETAINED EXISTING TREE TO BE REMOVED PERMANENT SURVEY MARK TEMPORARY BENCH MARK PROPOSED DRIVEWAY & FOOTPATH PROPOSED INDUSTRIAL DRIVEWAY PROPOSED SHARED FOOTPATH PROPOSED ROAD PAVING EXISTING ROAD PAVING

LEGEND - EARTHWORKS PLAN

ALL PROPOSED, FUTURE & EXISTING SERVICE LOCATIONS ARE SHOWN INDICATIVELY

WARNING
BEWARE OF UNDERGROUND SERVICES

he locations of underground services are approximate only and their exact position should be proven on site. No guarantee is given that all existing services are shown. ocate all underground services before commencement of works **DIAL 1100 BEFORE YOU DIG** www.1100.com.au

AMENDMENT / REVISION DESCRIPTION DATE 17.12.21

ISSUED FOR CONSTRUCTION


ELECTRICAL KIOSK RESERVE ADDED. LOT 91 DRIVEWAY AMENDMENTS 23.02.22 KIOSK RESERVE DIMENSION CHANGED 25.02.22 LENGTH OF PIPE AND PIT 123 ADDED


DES/DFT NG/SS LV JD BW LV JD

All setting out should be carried out in accordance with MPA/Council's





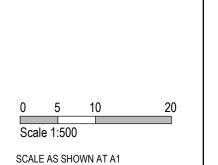

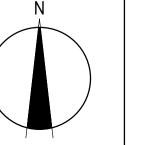





85-109 Farm road - Stage 3B Wyndham City Council Road and Drainage Earthwork Plan - 1

MELWAYS REF PROJECT / DRAWING No. 205 G12 2053E-03B-04

SHEET No. REVISION 3

ISSUED FOR CONSTRUCTION



ALL PROPOSED, FUTURE & EXISTING SERVICE LOCATIONS ARE SHOWN INDICATIVELY STORMWATER DRAIN, PIT & PROPERTY INLET MAIN DRAIN SWALE DRAIN SEWER & MAINTENANCE STRUCTURES ELECTRICITY (U.GROUND) ——0/H —— | ELECTRICITY (O.HEAD) TELSTRA OPTIC FIBRE ----- w ----- | WATER RECYCLE WATER AG. DRAIN —(GW)— SERVICE CONDUITS TACTILE PAVERS EXISTING STORMWATER DRAIN EXISTING MAIN DRAIN EXISTING SWALE DRAIN **EXISTING SEWER & MAINTENANCE ⊖**—Ex S—— STRUCTURES EXISTING HOUSE DRAIN ——Ех E —— EXISTING ELECTRICITY (UNDER GROUND) —0/Н E — EXISTING ELECTRICITY OVERHEAD <u>—</u>Ех G — EXISTING GAS <u>—</u>Ех Т — EXISTING TELSTRA <u>—</u>Ех 0 — EXISTING OPTIC FIBRE EXISTING WATER —Ex W — EXISTING RECYCLED WATER —Ex RW — —Ех.Ад — EXISTING AG. DRAIN EXISTING SERVICE CONDUITS EXISTING TACTILE PAVERS **FUTURE STORMWATER DRAIN FUTURE MAIN DRAIN** FUTURE SWALE DRAIN FUTURE SEWER & MAINTENANCE O-FUT S -STRUCTURES **FUTURE HOUSE DRAIN** FUTURE ELECTRICITY (UNDER GROUND) —_Fut E — FUTURE ELECTRICITY OVERHEAD -FutO/H E -FUTURE GAS ----Fut T -**FUTURE TELSTRA** —Fut 0 -FUTURE OPTIC FIBRE —Fut W -FUTURE WATER —Fut RW — FUTURE RECYCLED WATER FUTURE AG. DRAIN FUTURE SERVICE CONDUITS FUTURE TACTILE PAVERS ZERO LOT LINES - - -EXISTING SURFACE LEVEL FS140.35 FINISHED BUILDING LINE LEVEL FINISHED RIDGE LINE LEVEL FR157.40 CH270.00 CHAINAGE TOP OF RETAINING WALL LEVEL BOTTOM OF RETAINING WALL LEVEL BW159.00 **EXISTING RETAINING WALL** RETAINING WALL FUTURE RETAINING WALL STRUCTURAL FILL > 200mm DEEP EXISTING STRUCTURAL FILL > 200mm DEEP CUT > 200mm DEEP DIRECTION OF FALL OVERLAND FLOW GRADED IN DIRECTION OF FALL TO LEVEL INDICATED EDGE STRIP, SUBSOIL DRAIN, "NO ROAD" SIGN & BARRIER EXISTING TREE TO BE RETAINED EXISTING TREE TO BE REMOVED PERMANENT SURVEY MARK TEMPORARY BENCH MARK PROPOSED DRIVEWAY & FOOTPATH PROPOSED INDUSTRIAL DRIVEWAY PROPOSED SHARED FOOTPATH PROPOSED ROAD PAVING EXISTING ROAD PAVING

LEGEND - EARTHWORKS PLAN

WARNING
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07.06.21 SHARED PATH SHOWN AS EXISTING SUBJECT TO APPROVAL

AMENDMENT / REVISION DESCRIPTION

ISSUED TO COUNCIL FOR APPROVAL

30.04.21

standard drawings or as nominated on hard copy plans provided by SMEC. Any digital information supplied by this office is for information only. Any discrepancies should be discussed with the superintendent.


DES/DFT APPROVAL


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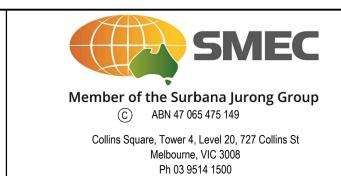
NG/SS

NG/SH





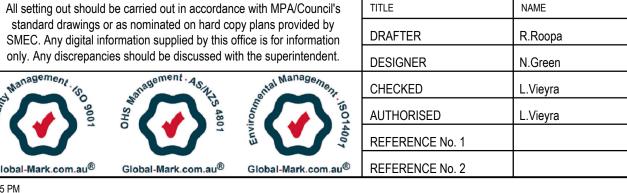


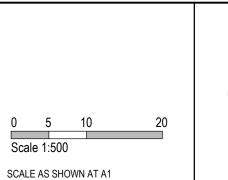






85-109 Farm road - Stage 3B Wyndham City Council Road and Drainage Earthwork Plan - 2


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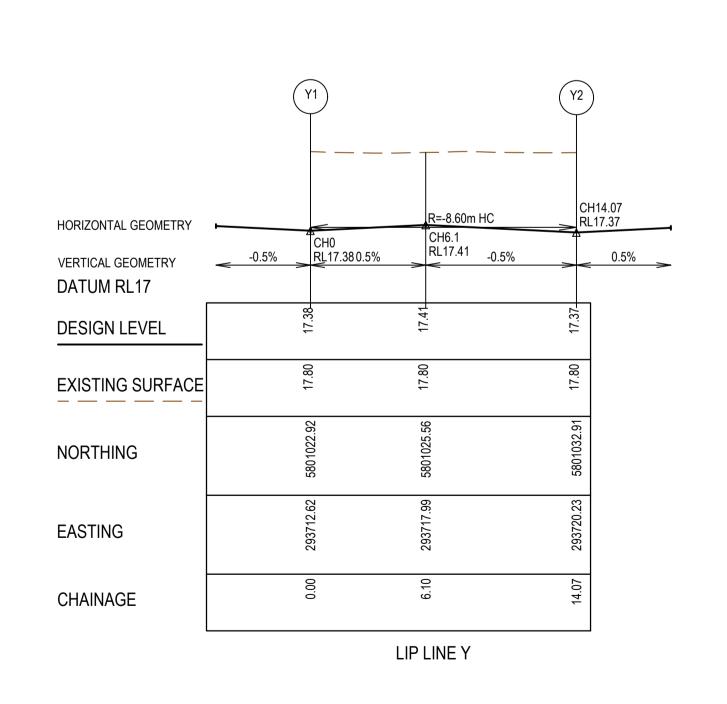


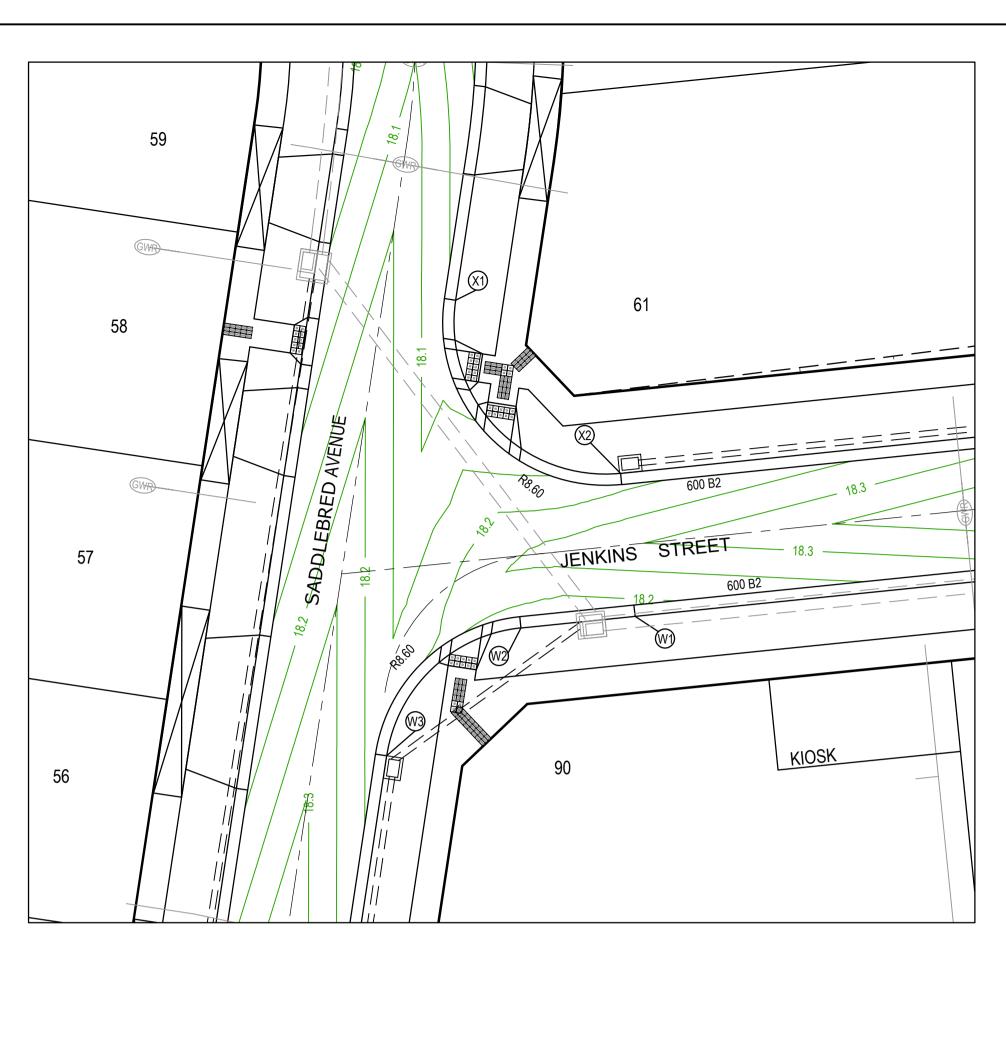

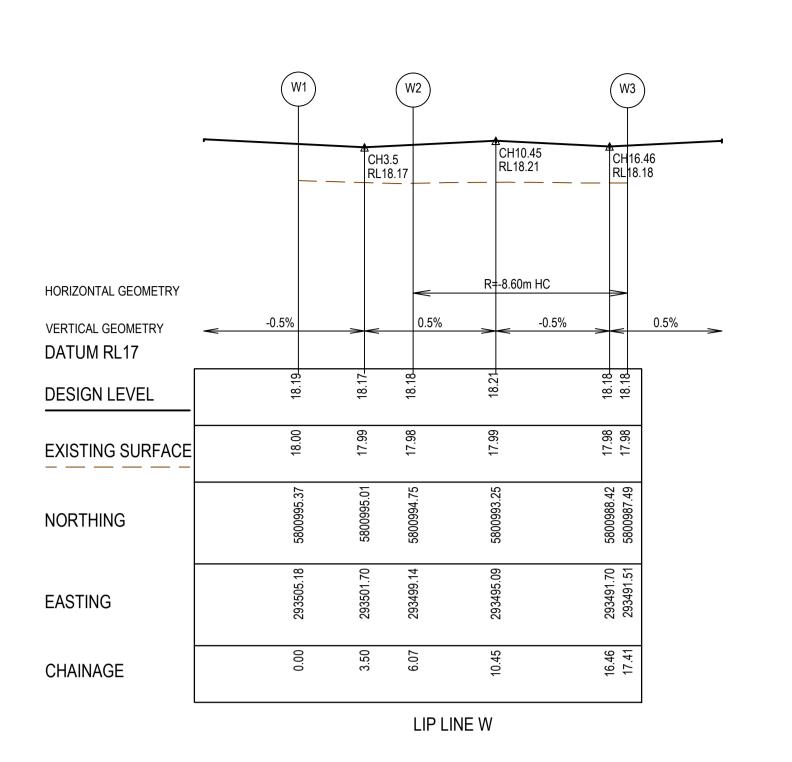

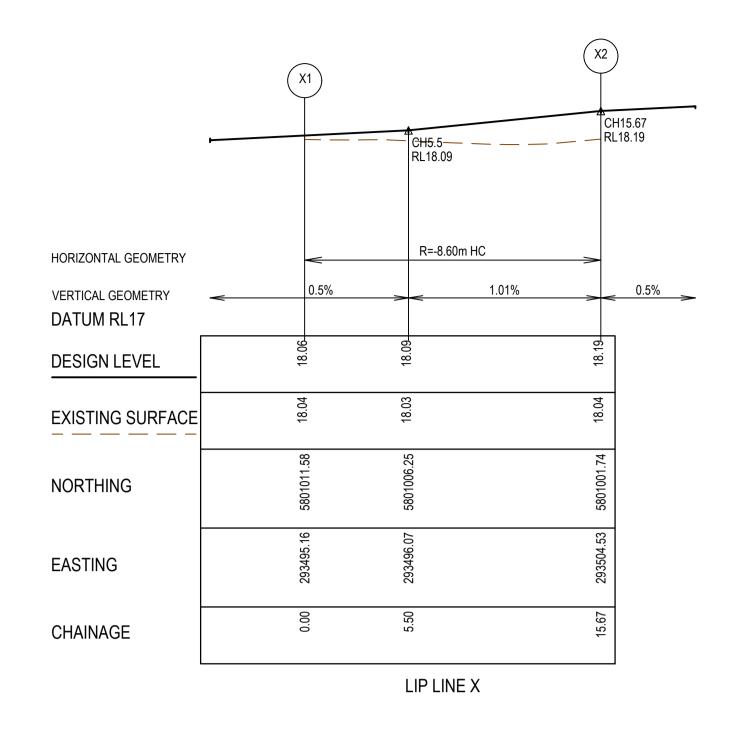

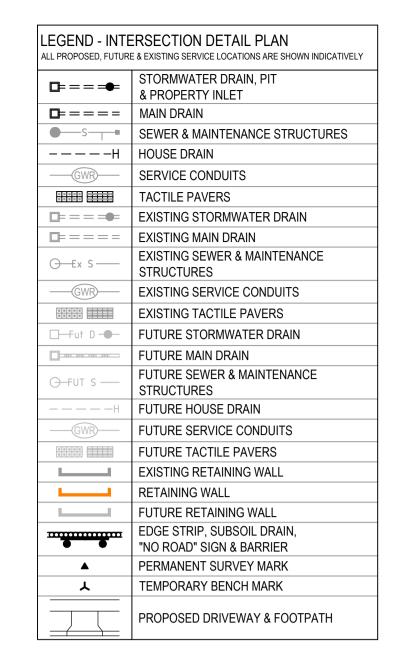

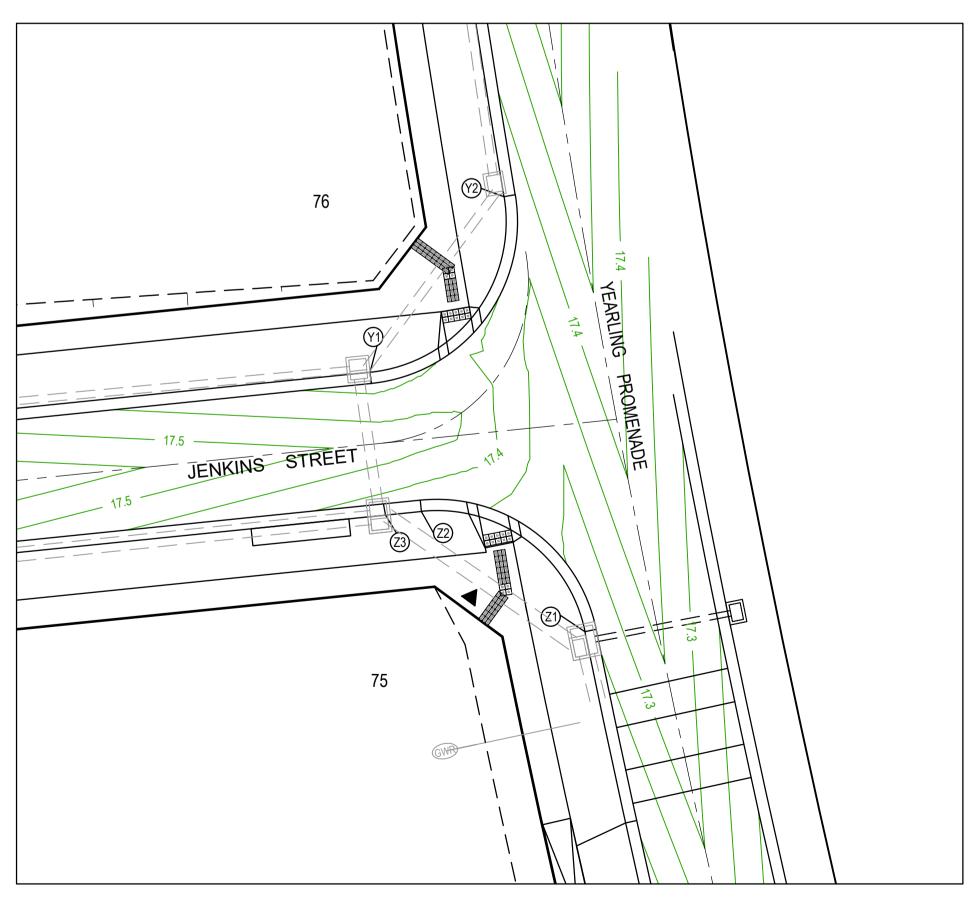



LIP LINE Z

NOTES

1. ALL VEHICLE CROSSINGS AND PRAM CROSSINGS TO BE MINIMUM OF 0.75m FROM PITS.

2. ALL PRAM CROSSINGS TO BE MINIMUM OF 2.0m FROM VEHICLE CROSSINGS.

VEHICLE EXCLUSION MEASURES BETWEEN ROAD RESERVE AND RESERVE TO FORM PART OF THE LANDSCAPE WORKS.

INDUSTRIAL DRIVEWAYS TO COUNCIL RESERVES TO BE PROVIDED AS PART OF LANDSCAPE WORKS. SHARE PATH THROUGH CREEK CORRIDOR TO FORM PART OF LANDSCAPE WORKS.

SUBJECT TO APPROVAL


AMENDMENT / REVISION DESCRIPTION


30.04.21 ISSUED TO COUNCIL FOR APPROVAL





ŭ	be carried out in accordance	TITLE	NAME	
	r as nominated on hard cop ormation supplied by this o	DRAFTER	R.Roopa	
only. Any discrepanci	es should be discussed wit	DESIGNER	N.Green	
Management Iso 9001	agragement. Agray	ental Management	CHECKED	L.Vieyra
9001	S 480.	SO14007	AUTHORISED	L.Vieyra
		Envi	REFERENCE No. 1	
Global-Mark.com.au®	Global-Mark.com.au [®]	Global-Mark.com.au®	REFERENCE No. 2	
1:32 PM				

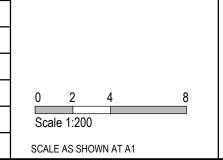

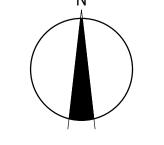







85-109 Farm road - Stage 3B Wyndham City Council Road and Drainage Intersection Detail Plan

MELWAYS REF PROJECT / DRAWING No. 205 G12 2053E-03B-06

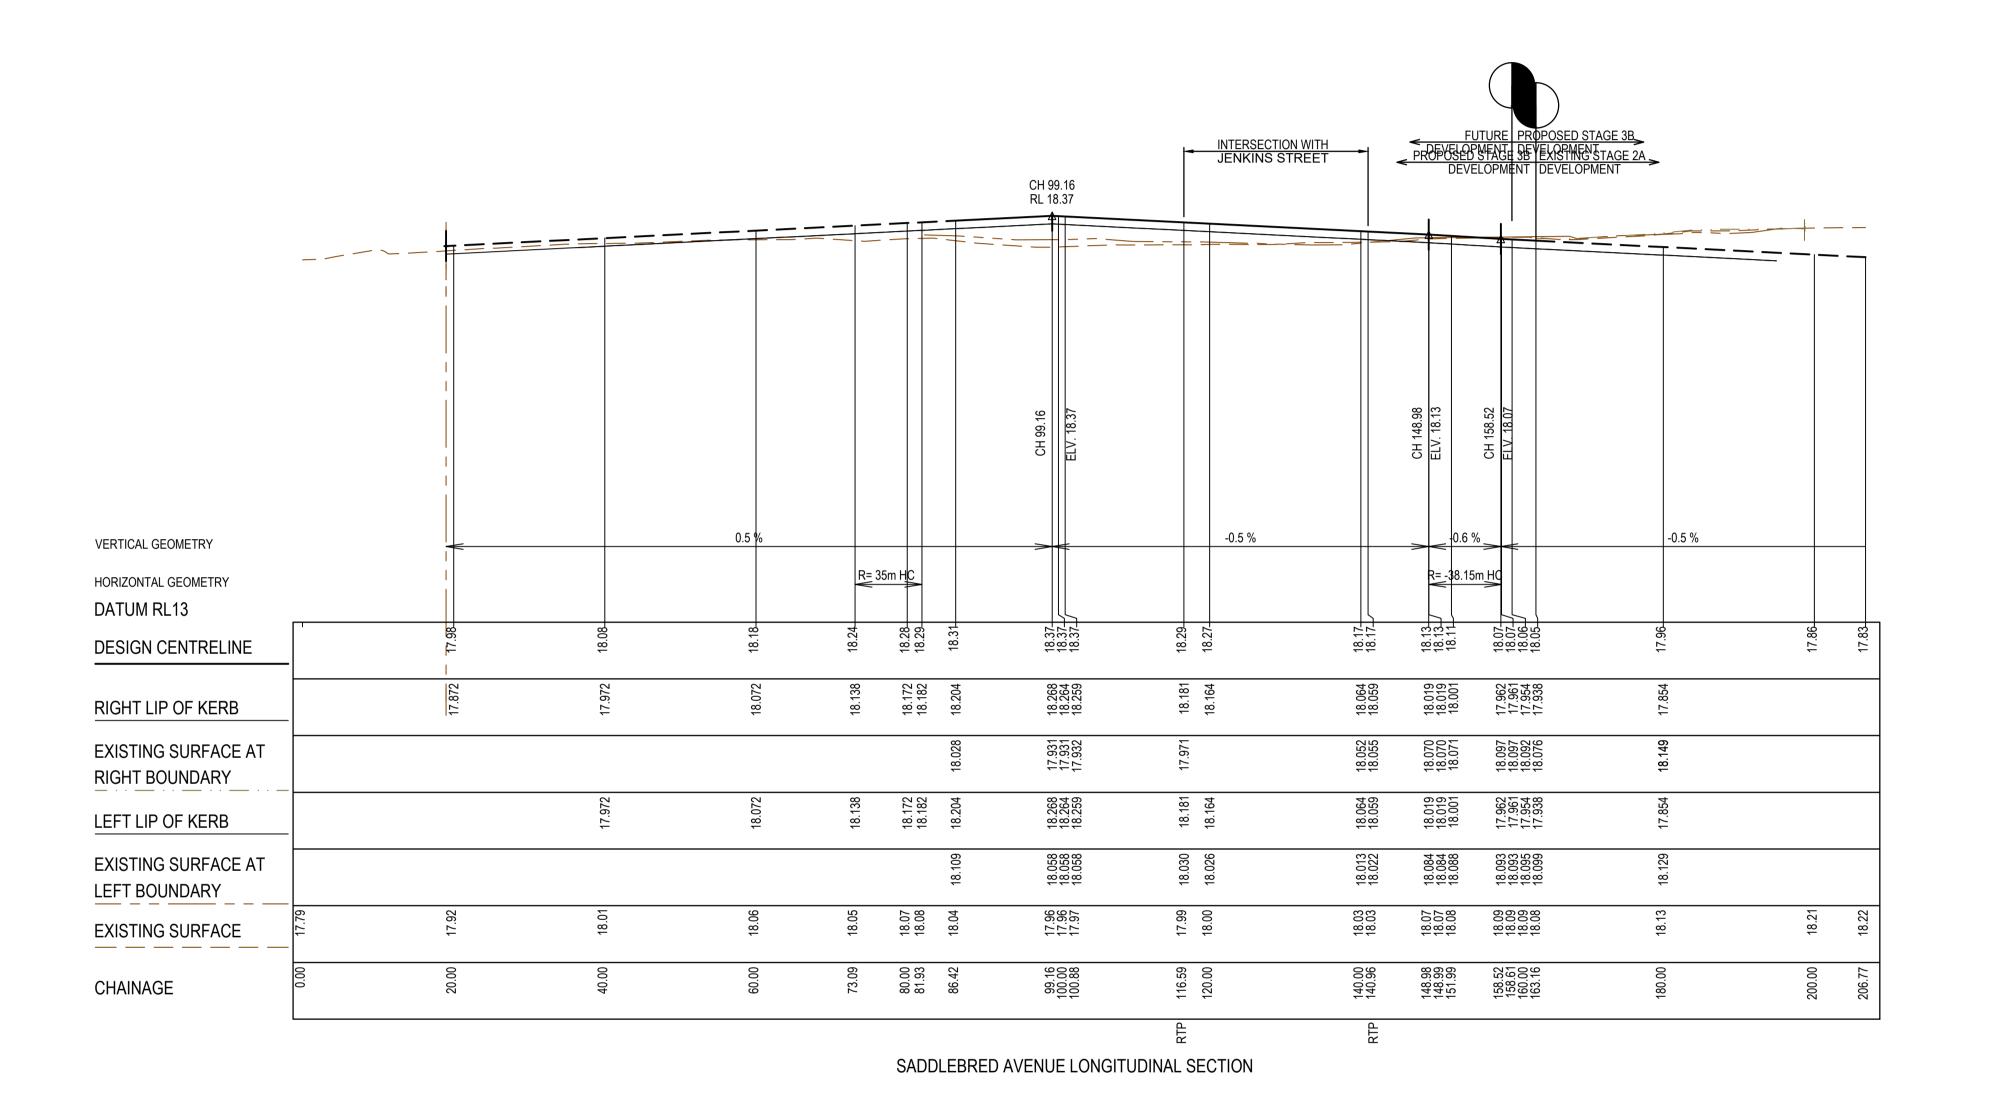

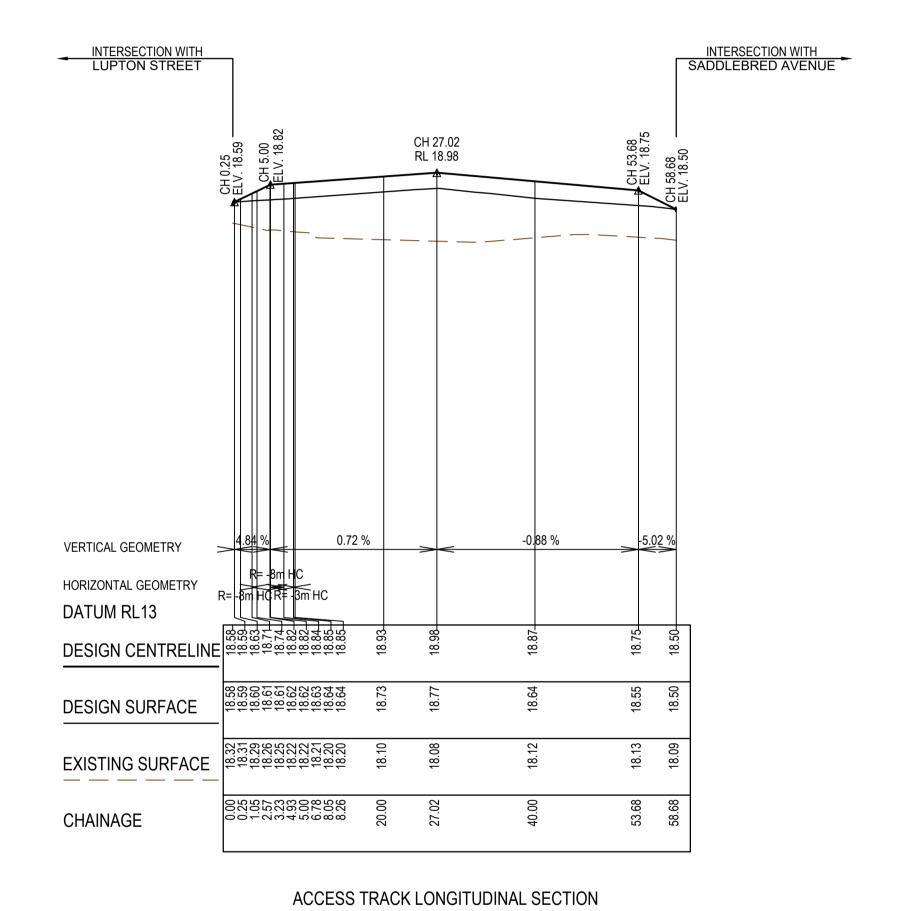

AMENDMENT / REVISION DESCRIPTION DATE DES/DFT APPROVAL All setting out should be carried out in accordance with MPA/Council's NAME standard drawings or as nominated on hard copy plans provided by SMEC. Any digital information supplied by this office is for information 30.04.21 ISSUED TO COUNCIL FOR APPROVAL NG/SS DRAFTER R.Roopa only. Any discrepancies should be discussed with the superintendent. DESIGNER N.Green L.Vieyra 0 5 10 20 0 0.5 1 2 Scale H1:500, V1:50 SCALE AS SHOWN AT A1 AUTHORISED L.Vieyra

REFERENCE No. 1


SMEC Member of the Surbana Jurong Group
© ABN 47 065 475 149 Collins Square, Tower 4, Level 20, 727 Collins St

Melbourne, VIC 3008 Ph 03 9514 1500

85-109 Farm road - Stage 3B
Wyndham City Council
Road and Drainage
Longitudinal Sections - 1

MELWAYS REF PROJECT / DRAWING No. 205 G12 2053E-03B-07 SHEET No. REVISION 0

SUBJECT TO APPROVAL

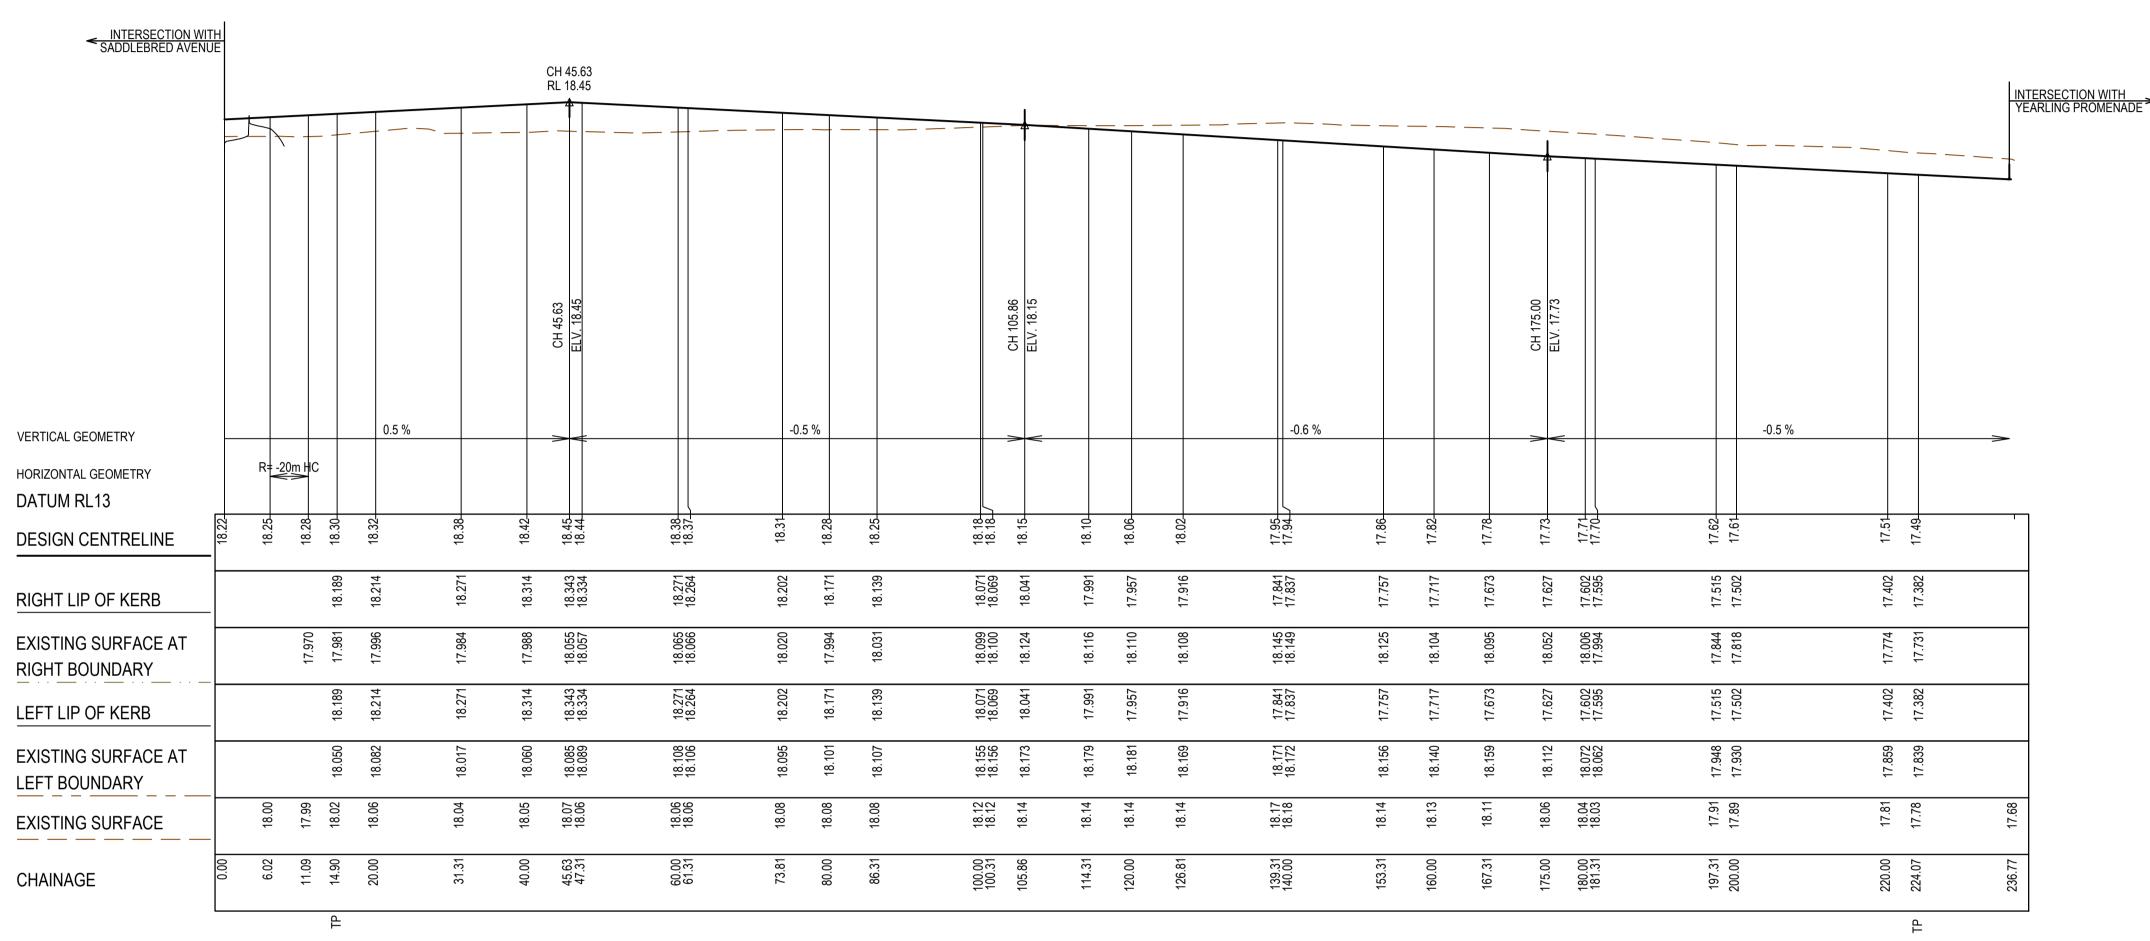

JENKINS STREET LONGITUDINAL SECTION

SUBJECT TO APPROVAL


AMENDMENT / REVISION DESCRIPTION

30.04.21 ISSUED TO COUNCIL FOR APPROVAL



All setting out should be carried out in accordance with MPA/Council's

DES/DFT APPROVAL

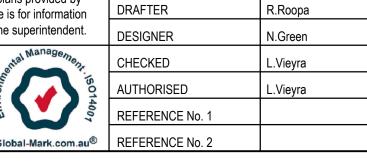

NAME


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85-109 Farm road - Stage 3B Wyndham City Council Road and Drainage Longitudinal Sections - 2

MELWAYS REF PROJECT / DRAWING No. 205 G12 2053E-03B-08 SHEET No. REVISION 0



SUBJECT TO APPROVAL


AMENDMENT / REVISION DESCRIPTION

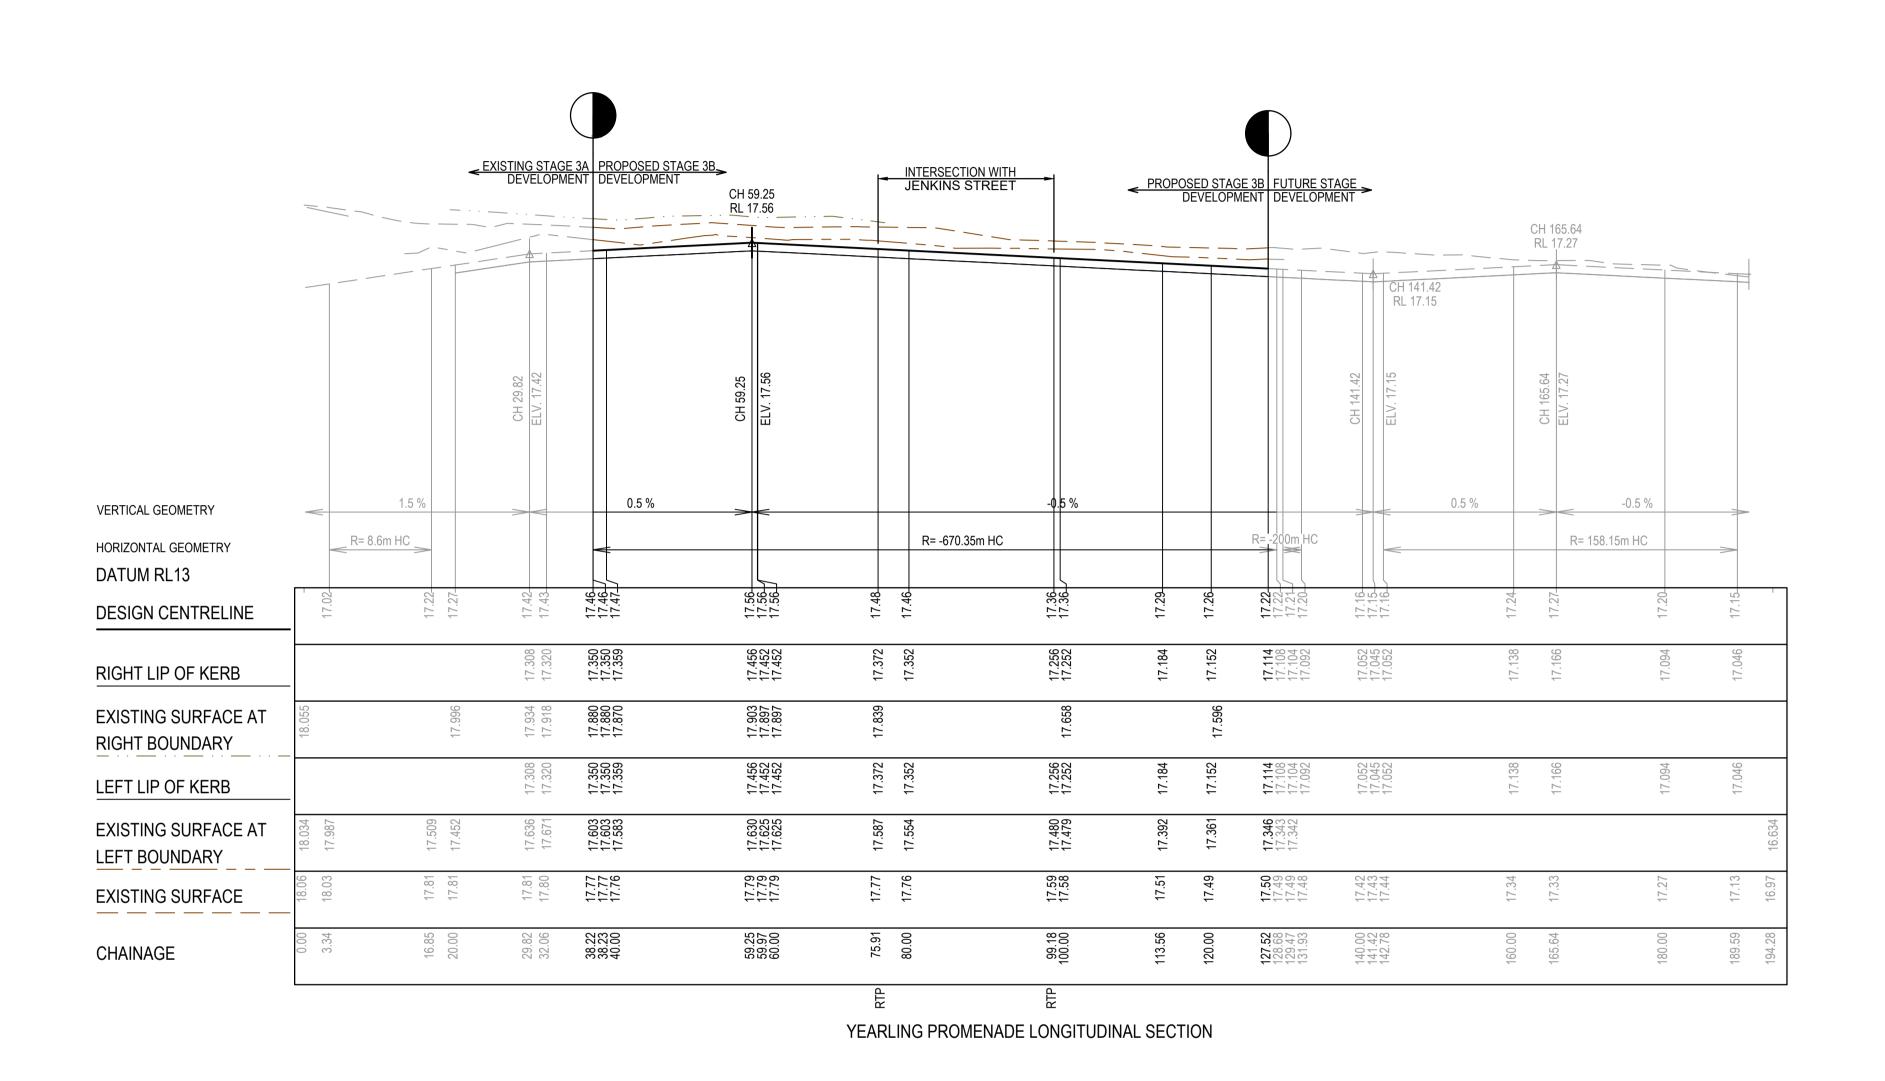30.04.21 ISSUED TO COUNCIL FOR APPROVAL



All setting out should be carried out in accordance with MPA/Council's



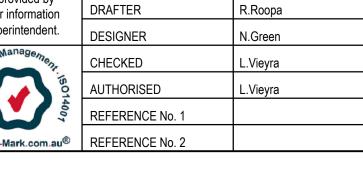


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85-109 Farm road - Stage 3B Wyndham City Council Road and Drainage Longitudinal Sections - 3

MELWAYS REF PROJECT / DRAWING No. 205 G12 2053E-03B-09 SHEET No. REVISION 0




LUPTON STREET LONGITUDINAL SECTION

SUBJECT TO APPROVAL

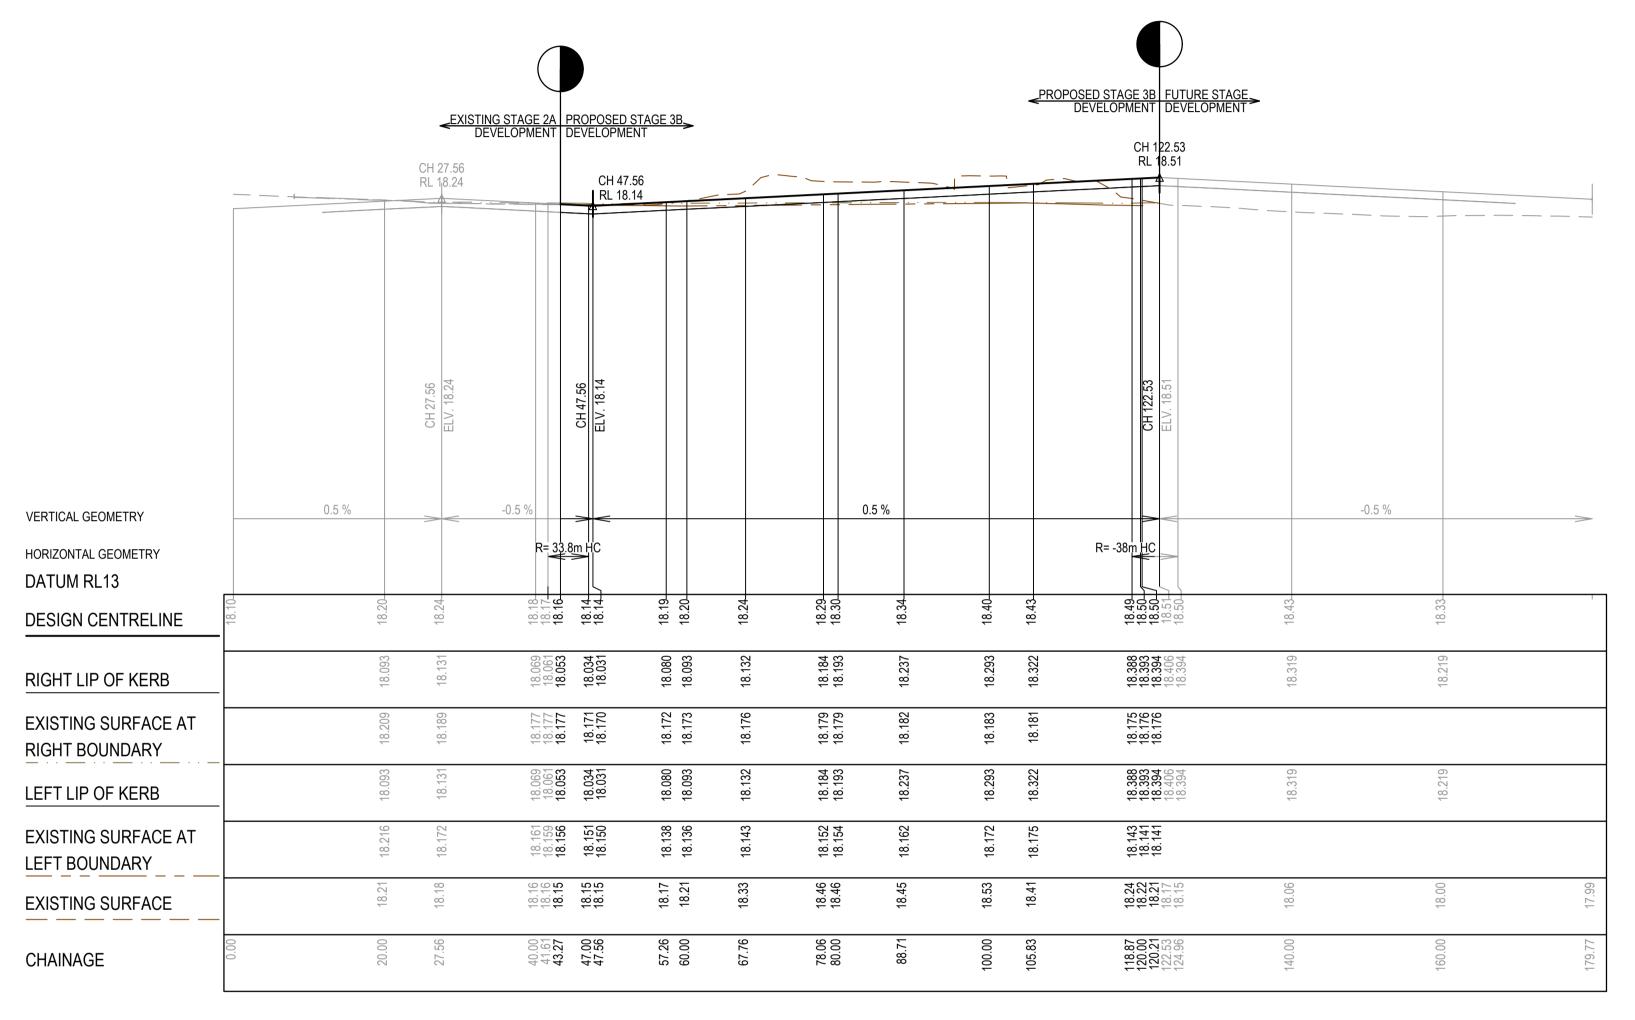
AMENDMENT / REVISION DESCRIPTION

30.04.21 ISSUED TO COUNCIL FOR APPROVAL

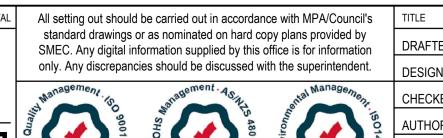

DES/DFT APPROVAL

e is for information	DRAFTER	К.Коора
he superintendent.	DESIGNER	N.Green
Management 15014007	CHECKED	L.Vieyra
15 O1	AUTHORISED	L.Vieyra
4007	REFERENCE No. 1	
Global-Mark.com.au®	REFERENCE No. 2	

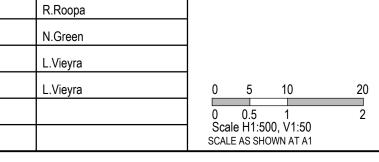








85-109 Farm road - Stage 3B
Wyndham City Council
Road and Drainage
Longitudinal Sections - 4


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 PROJECT / DRAWING No.
 SHEET No.
 REVISION


 205 G12
 2053E-03B-10
 10 of 20
 0

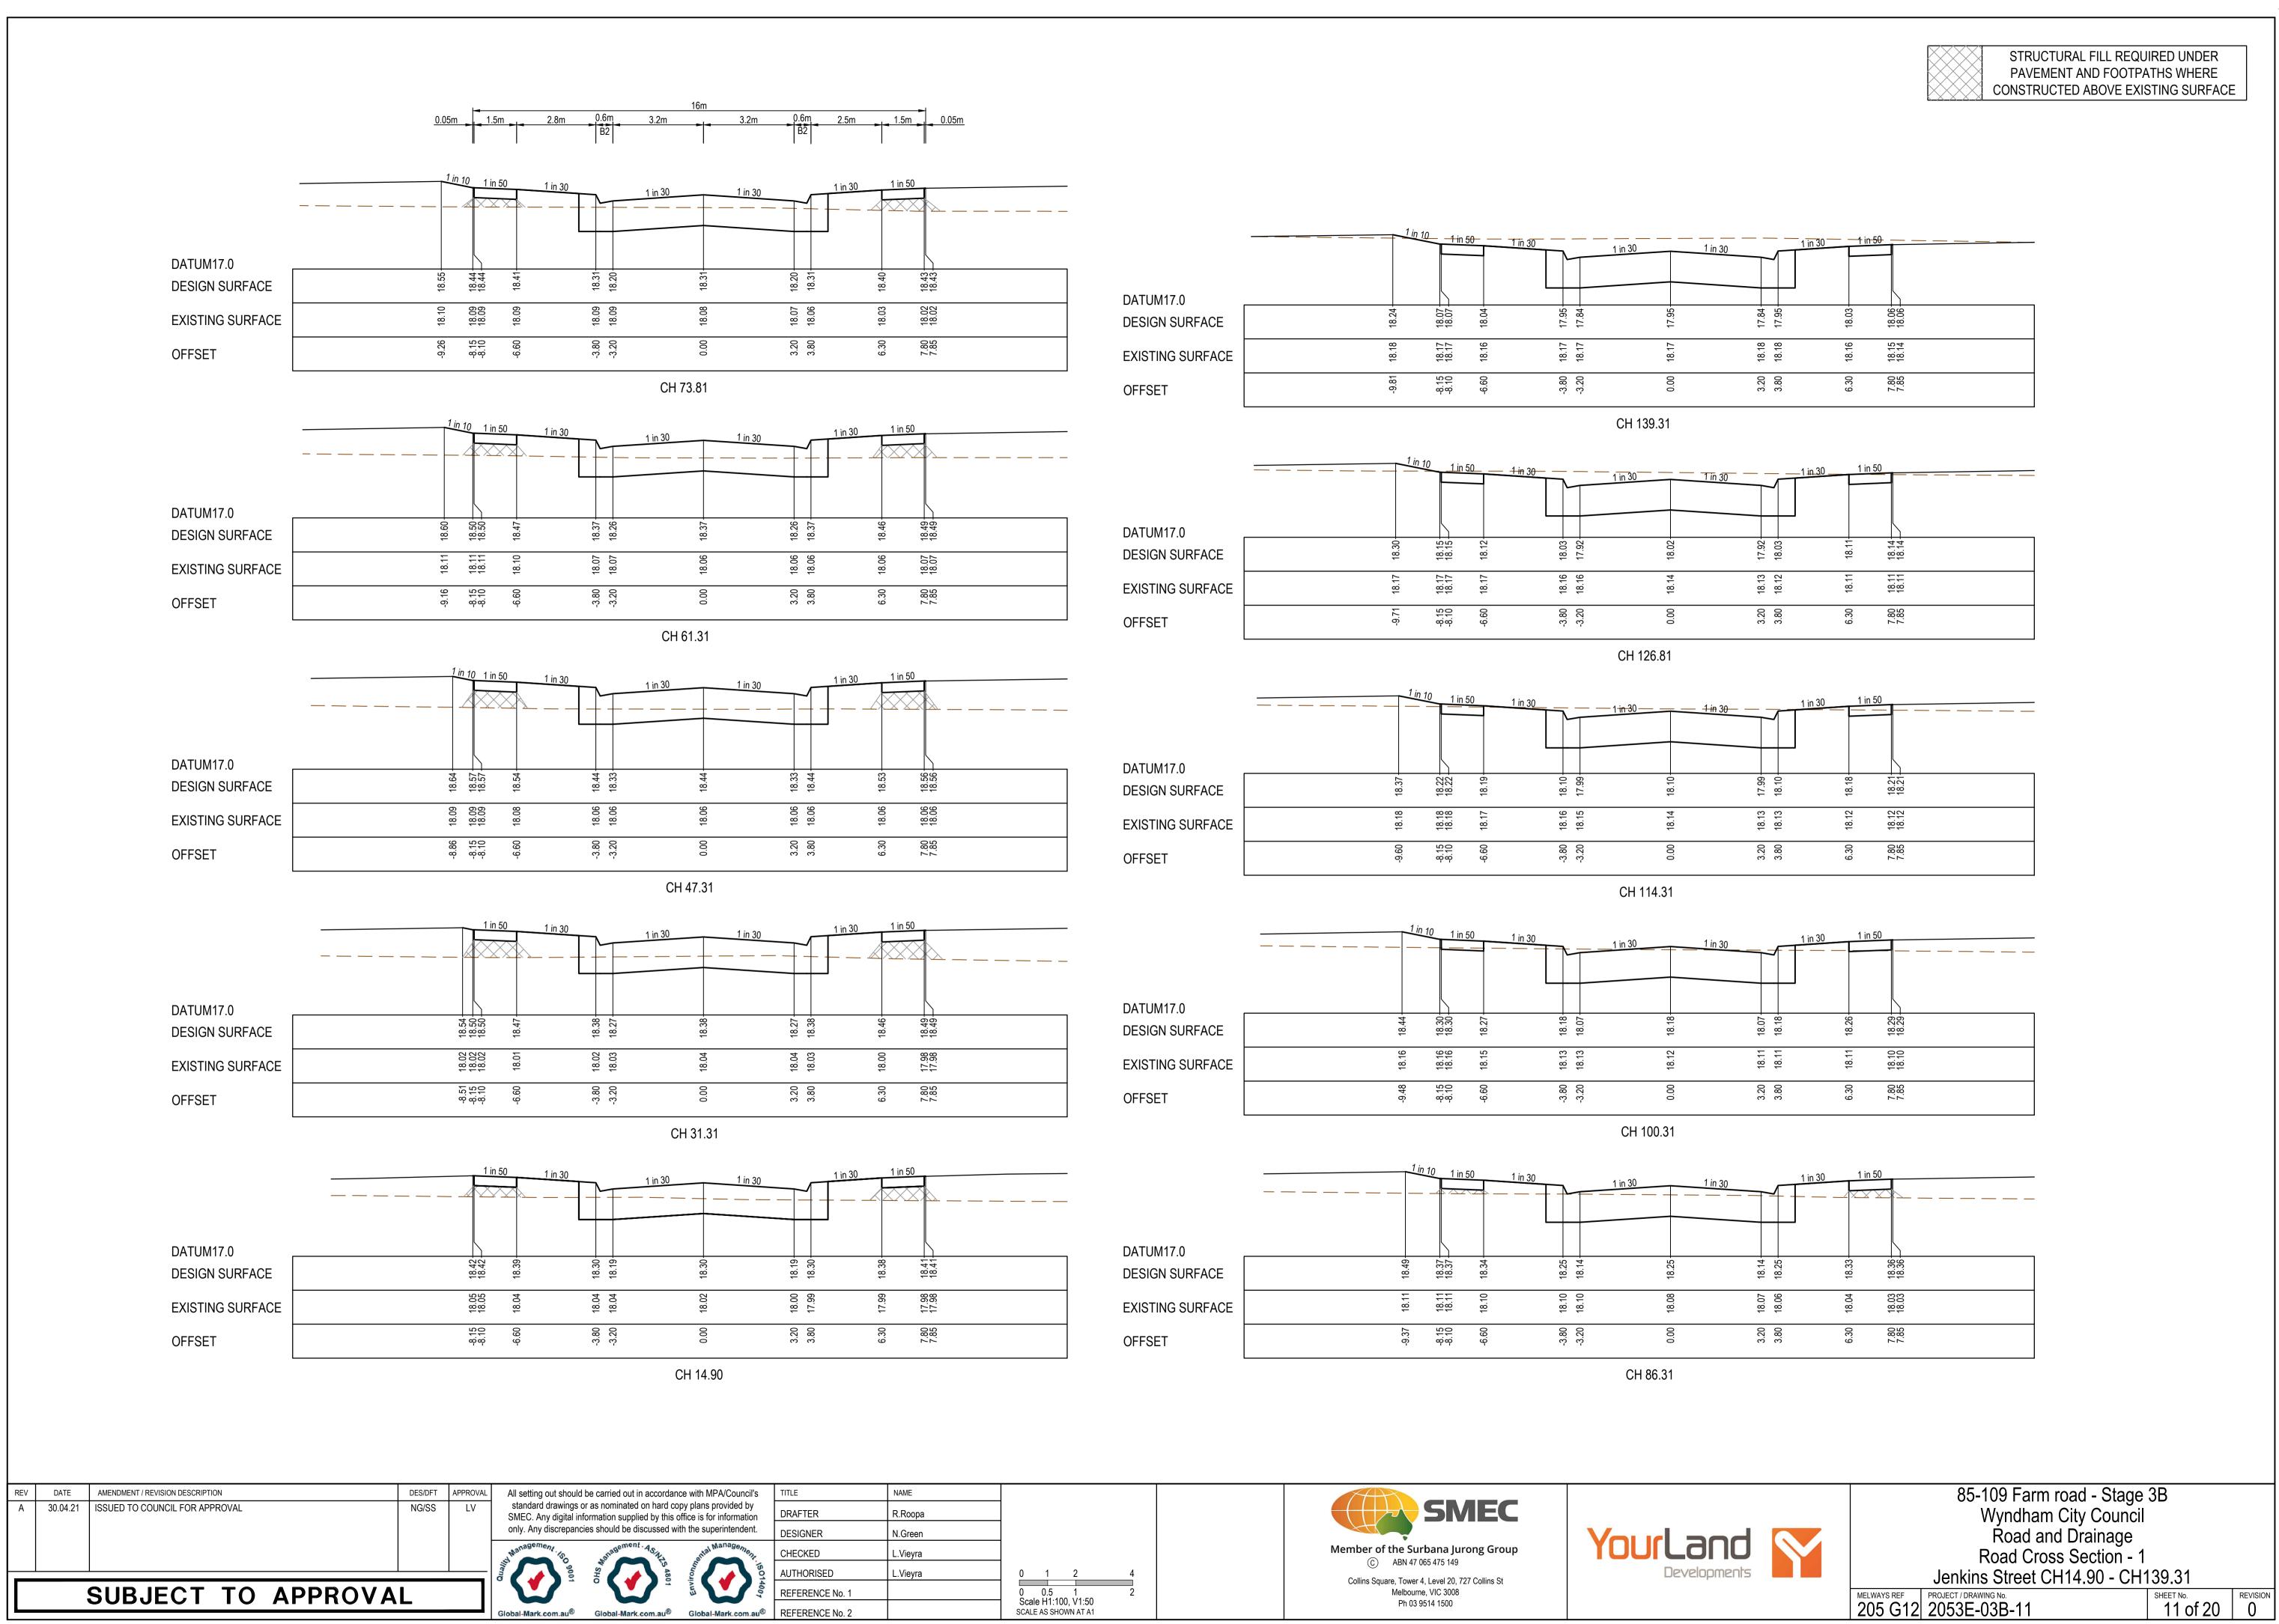


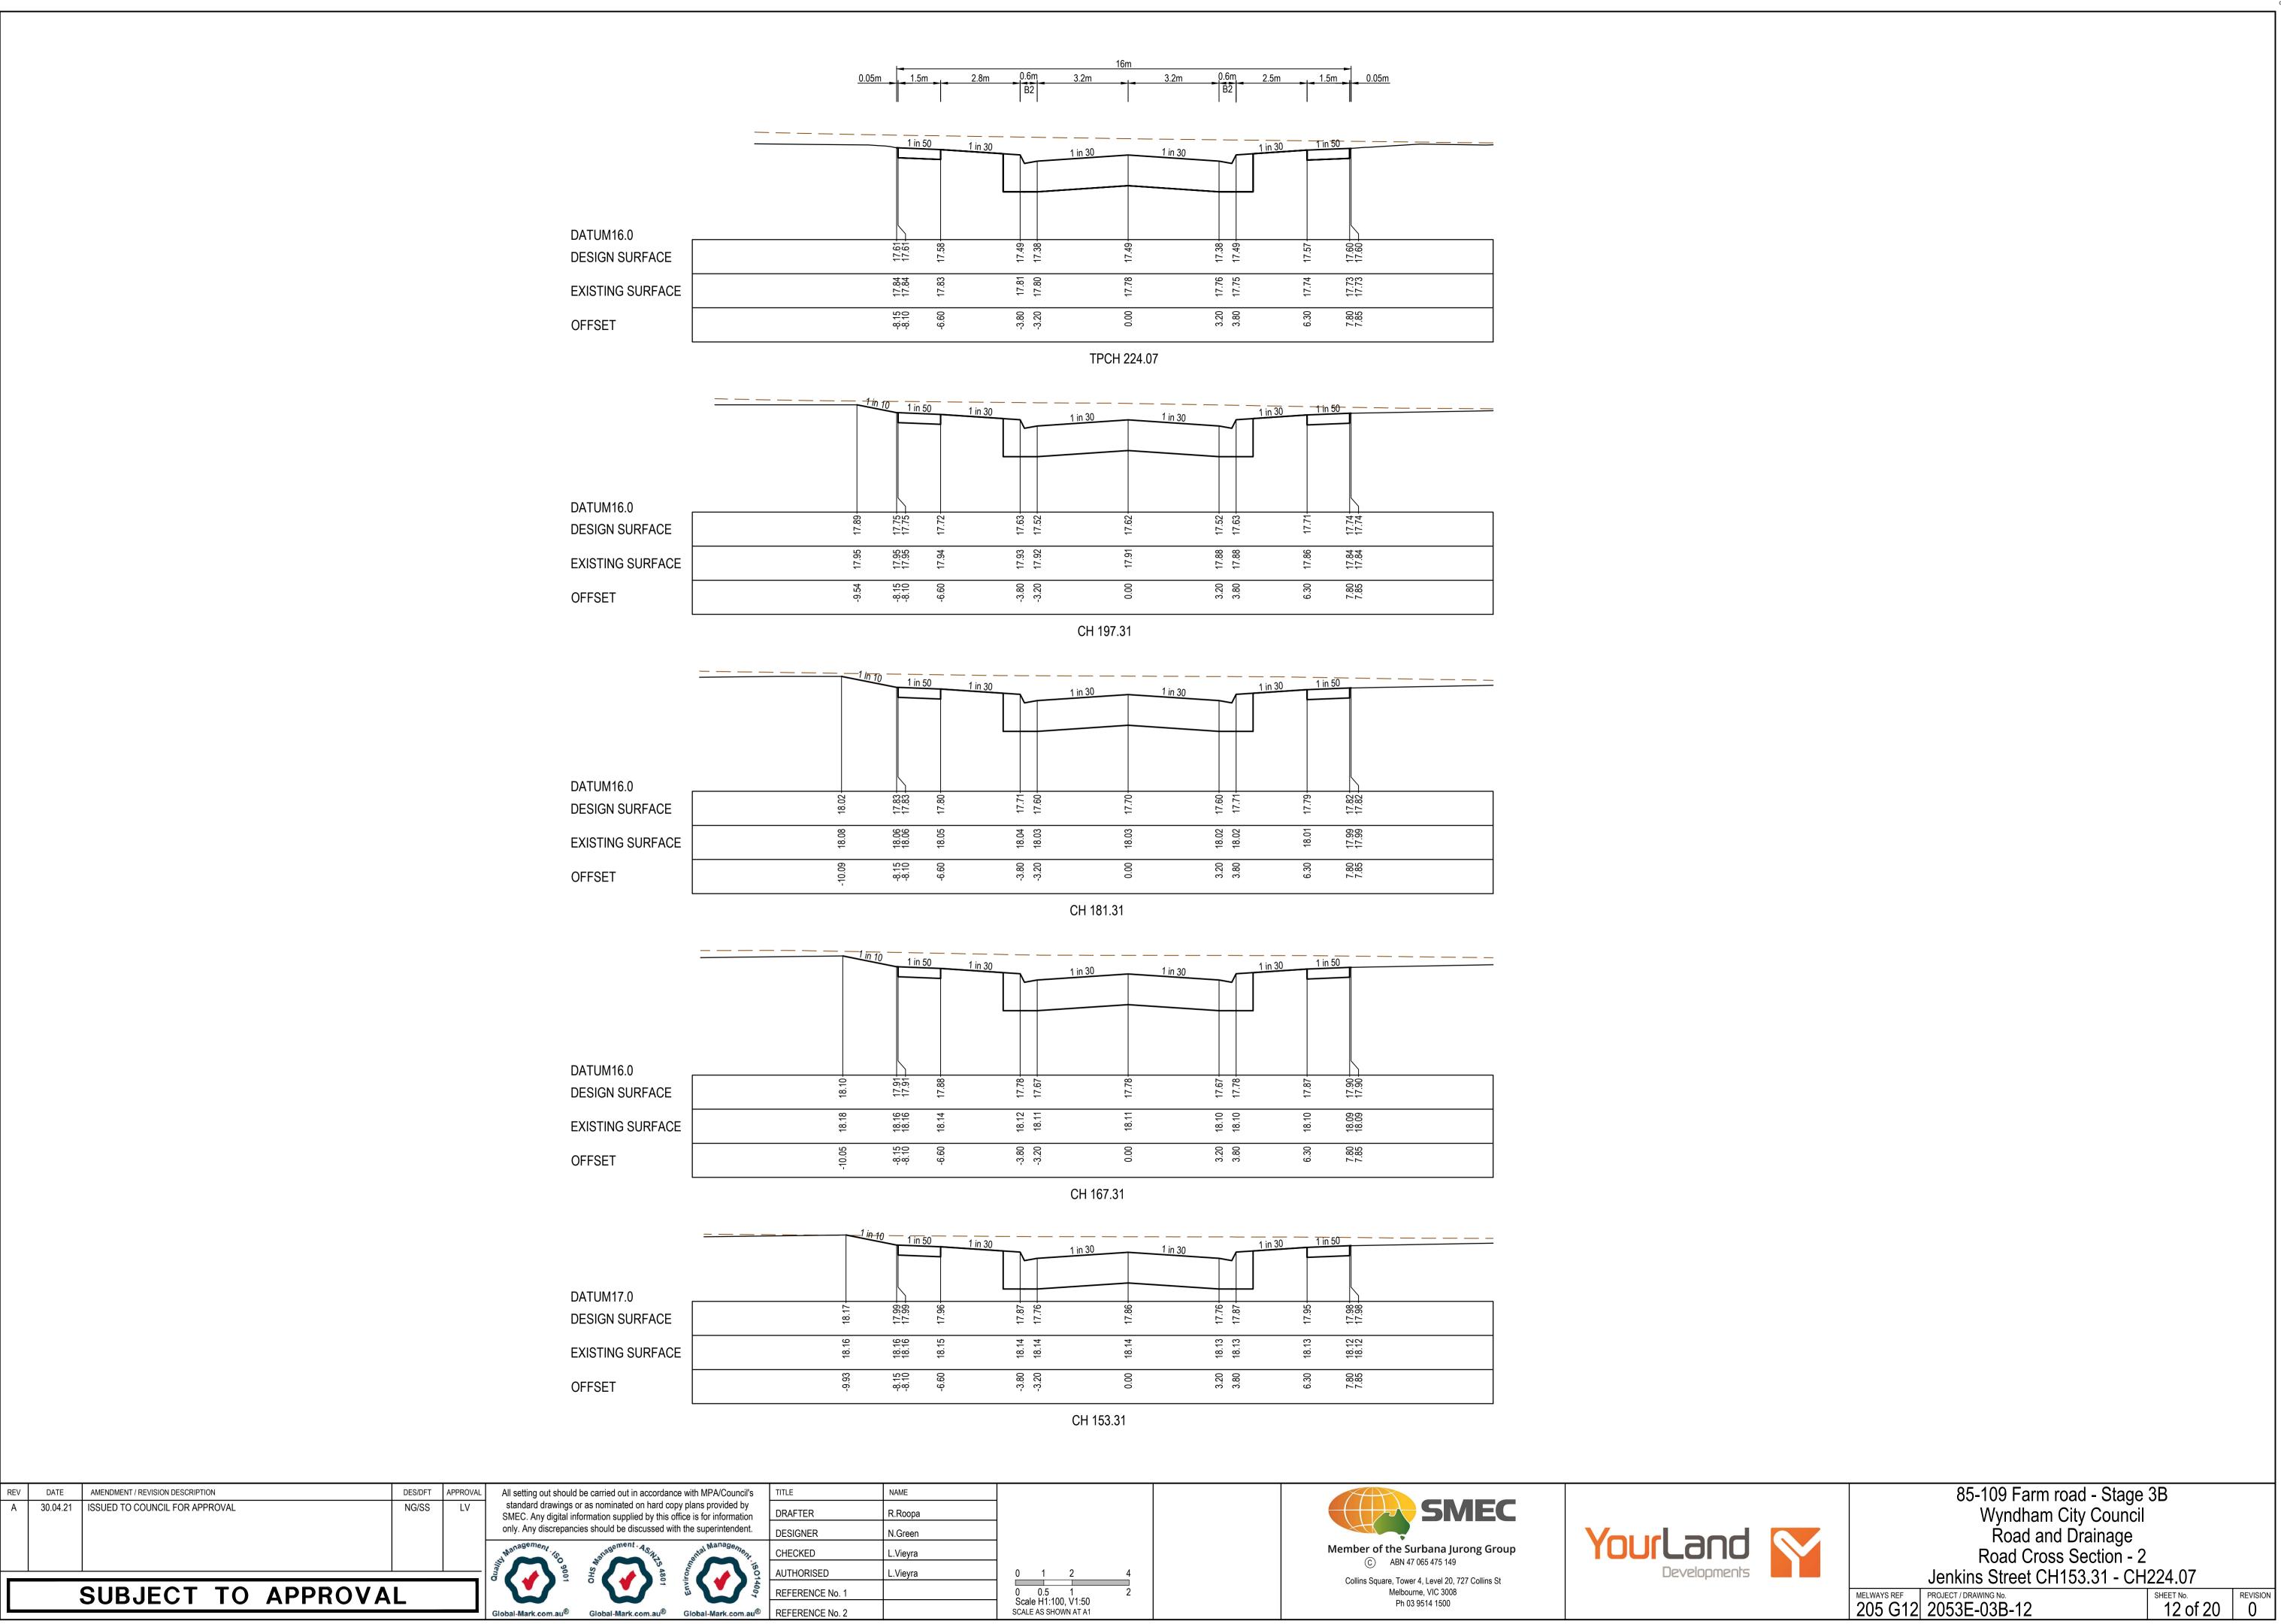

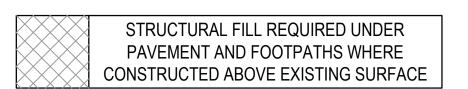

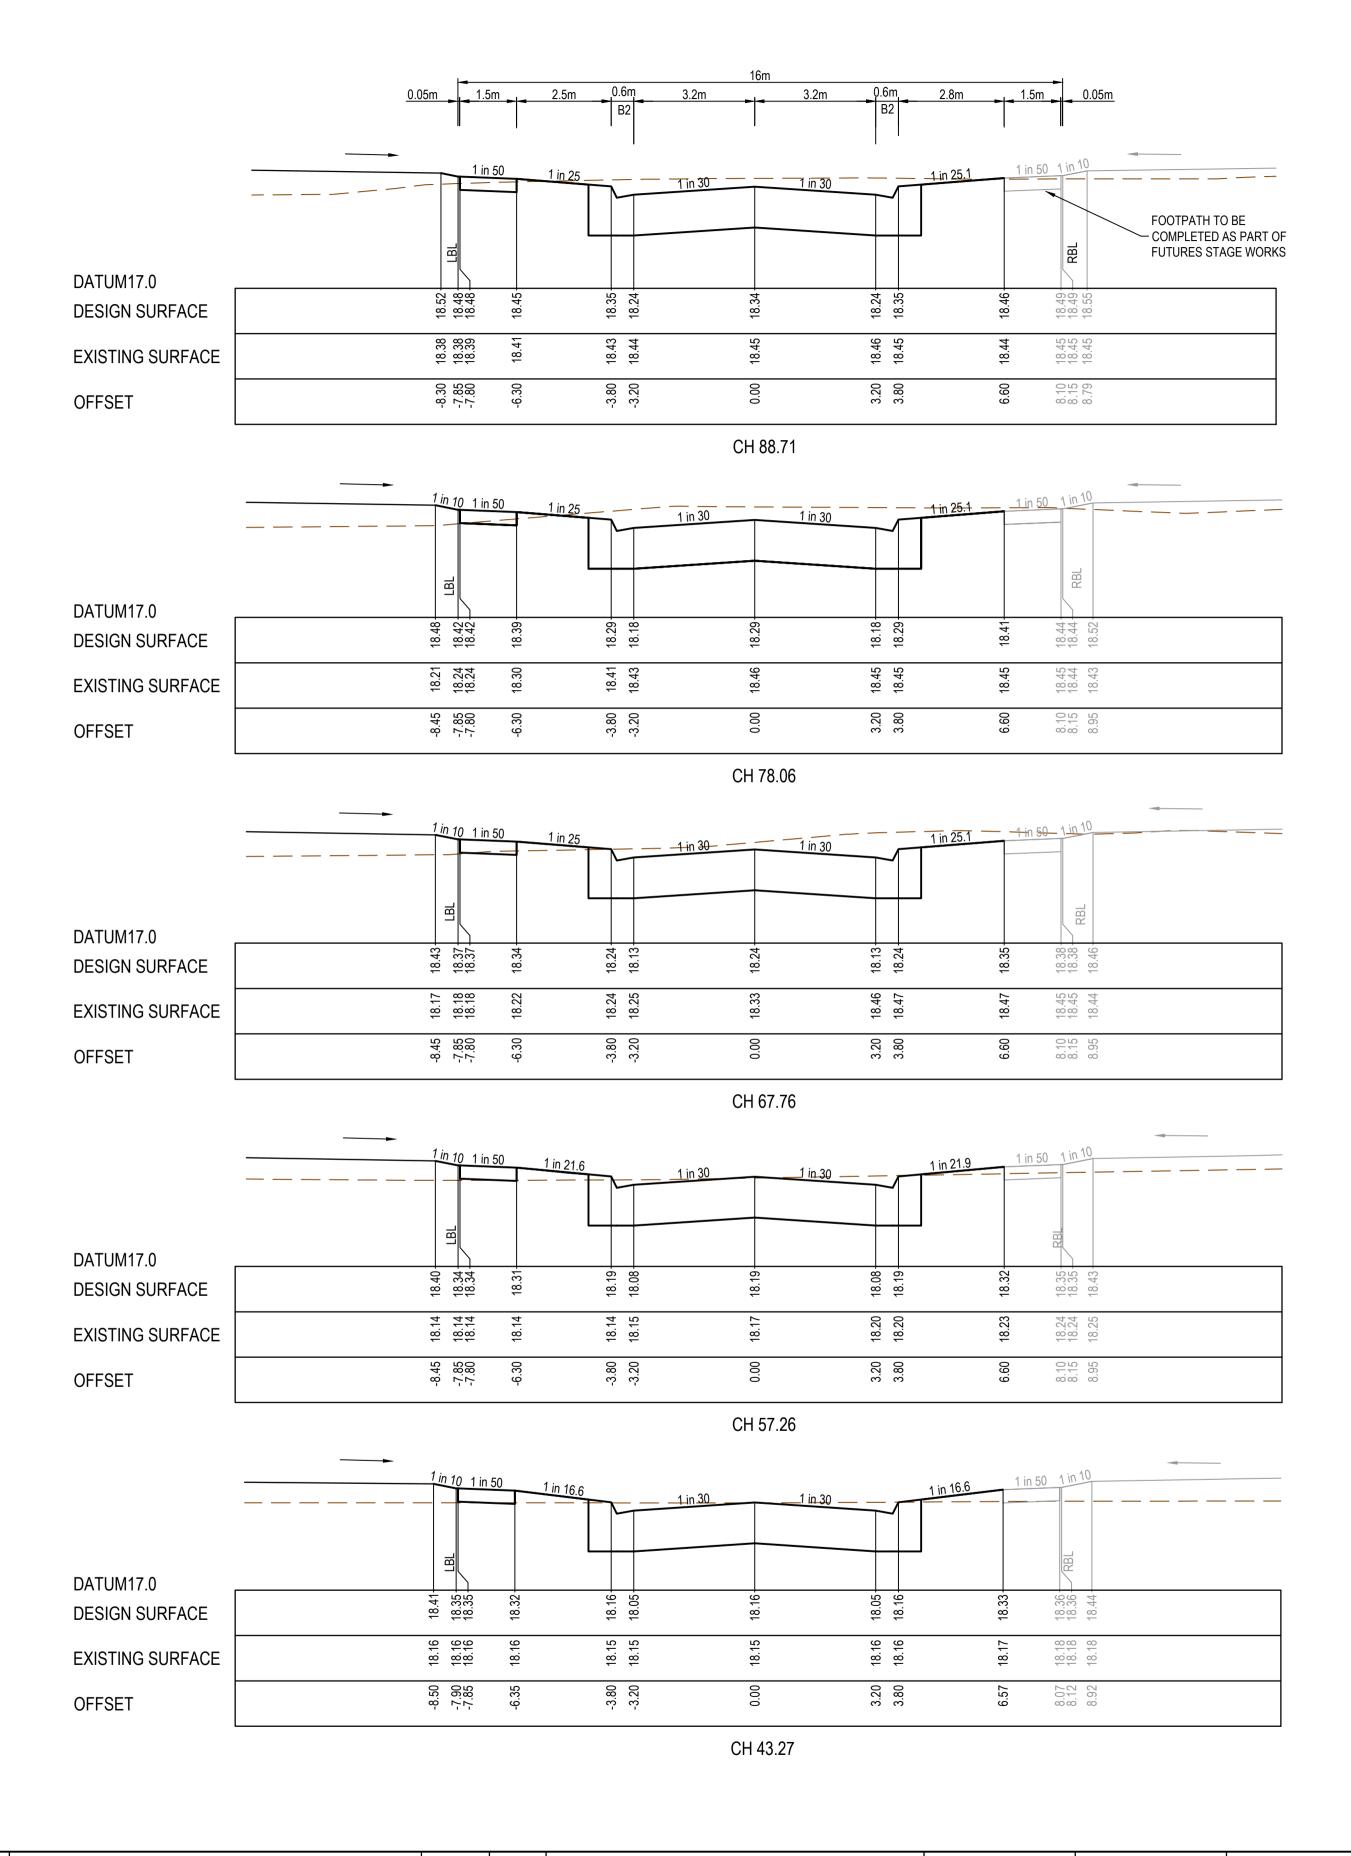

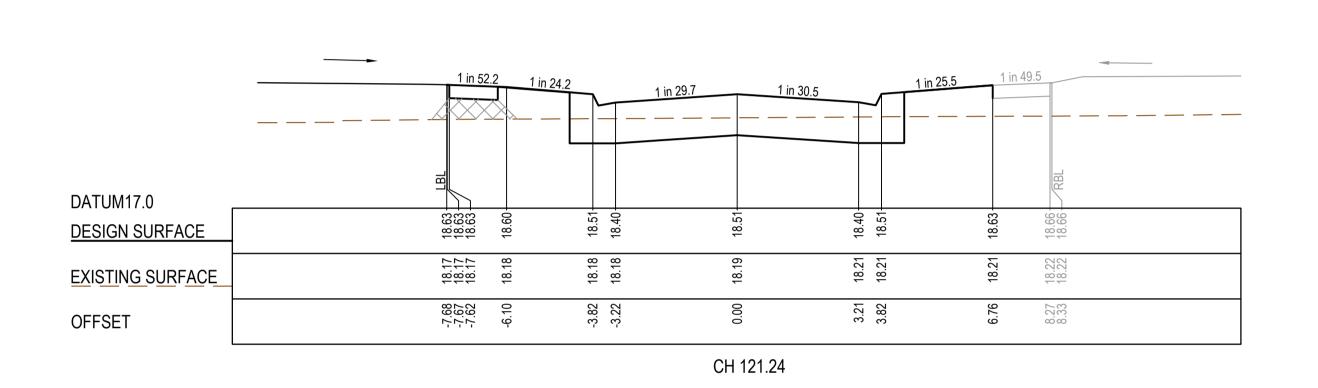

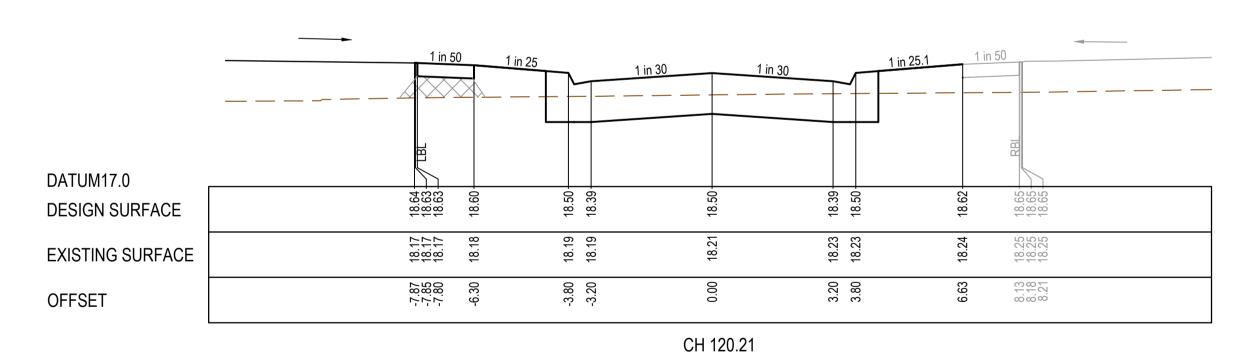

DATUM17.0

DESIGN SURFACE

EXISTING SURFACE

OFFSET

DATUM17.0

DESIGN SURFACE

(CH 105.83)


REV	DATE	AMENDMENT / REVISION DESCRIPTION
Α	30.04.21	ISSUED TO COUNCIL FOR APPROVAL

DES/DFT APPROVAL /

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this office is for information sed with the superintendent.

3	TITLE	NAME	
l	DRAFTER	R.Roopa	
,	DESIGNER	N.Green	
	CHECKED	L.Vieyra	
15014007	AUTHORISED	L.Vieyra	0 1 2
4007	REFERENCE No. 1		0 0.5 1
u®	REFERENCE No. 2		Scale H1:100, V1:50 SCALE AS SHOWN AT A1




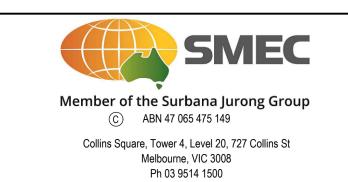



85-109 Farm road - Stage 3B
Wyndham City Council
Road and Drainage
Road Cross Section - 3
Lupton Street CH43.27 - CH120.21

| Cuptoff Street CH43.27 - CH120.21 | MELWAYS REF | PROJECT / DRAWING No. | SHEET No. | REVISION | 205 G12 | 2053E-03B-13 | 13 of 20 | 0

SUBJECT TO APPROVAL

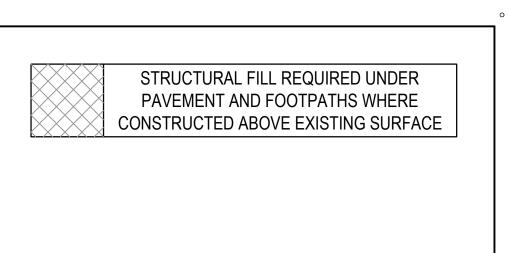

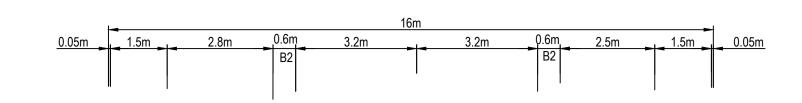

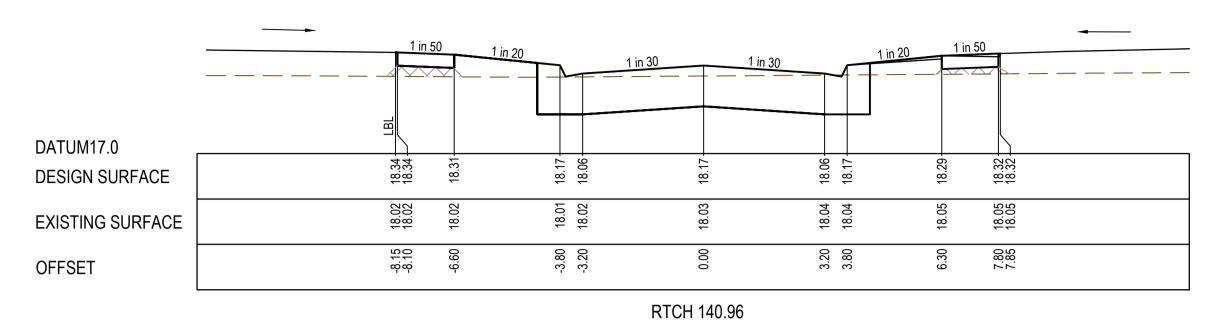

	177-577-170.00						
	 1 in 5	0 1 in	120	1 in 30 1 in 30	1 in 20	1 in 50	
DATUM17.0							
DESIGN SURFACE	18.46- 18.46-	18.43-	18.29-	18.29	18.18-	18.42- 18.45- 18.45-	
EXISTING SURFACE	18.03 18.03	18.02	18.00	17.99	17.98	17.97 17.97 17.97	
OFFSET	-8.15 -8.10	-6.60	-3.80	0.00	3.20	6.30	

RTCH 116.59

CH 100.88

		1 in 50	1 in 20	1 in 30	1 in 30	1 in 20	1 in 50	-
DATUM17.0	F				9			
DESIGN SURFACE	0	18.54-	18.37	18.37	18.26	18.37	18.49	18.52 22.
EXISTING SURFACE	90.07	18.04	18.01	17.97	17.93	17.93	17.93	17.93
OFFSET	0	-6.60 -6.60	-3.80	0.00	3.20	3.80	6.30	7.85


	 1 in 5	0 1 in 20		1 in 30	1 in 30	1 in 20	1 in 50	
DATUM17.0								
DESIGN SURFACE	18.48	18.45	18.31	18.31	18.20	18.44	18.47 18.47	
EXISTING SURFACE	18. 11. 11.	18.10	18.07	18.04	18.05	18.04	18.03 18.03	
OFFSET	-8.15 -8.10	-6.60	-3.20	0.00	3.20	6.30	7.80 7.85	

	CH 86.42											
		1 in 55	5.2 1 in 21.2		1 in 29.8	1 in 32.2	+		1 in 20.1	1 in 48.5		
DATUM17.0								<u> </u>				
DESIGN SURFACE		18.46 18.46	18.44	18.30	20 20 20 20 20 20 20 20 20 20 20 20 20 2	18.30	18.20	18.31		18.44	18.47	
EXISTING SURFACE		18.12 18.12	18. 11.	18.09	% 0. 80.	18.07	18.06	18.06		18.04	18.03 18.03	
OFFSET		-8.11 -8.06	-6.51	-3.61	3.00	0.31	3.61	4.23		6.82	8.37	
					СН	84.39						

NG/SS

All setting out should be carried out in accordance with MPA/Council's standard drawings or as nominated on hard copy plans provided by SMEC. Any digital information supplied by this office is for information only. Any discrepancies should be discussed with the superintendent. DESIGNER

R.Roopa L.Vieyra AUTHORISED REFERENCE No. 1 SCALE AS SHOWN AT A1

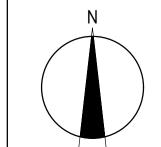



18.28 18.28

18.09 18.09

-8.15 -8.10 -6.60

18.22

18.10 18.10 18.10

-8.15 -8.10 -6.60

17.94 18.05

18.07 18.07

3.20

3.20

18.20 18.20

18.08 18.08

7.80

18.27 18.27

85-109 Farm road - Stage 3B
Wyndham City Council
Road and Drainage
Road Cross Section - 4
Saddlebred Avenue CH86.42 - CH163.16


MELWAYS REF PROJECT / DRAWING No. 205 G12 2053E-03B-14 SHEET No. REVISION 0

SUBJECT TO APPROVAL

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AMENDMENT / REVISION DESCRIPTION

30.04.21 ISSUED TO COUNCIL FOR APPROVAL

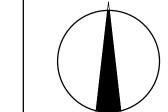

DATUM17.0

OFFSET

DATUM17.0

OFFSET

DESIGN SURFACE

EXISTING SURFACE

DESIGN SURFACE

EXISTING SURFACE

18.10


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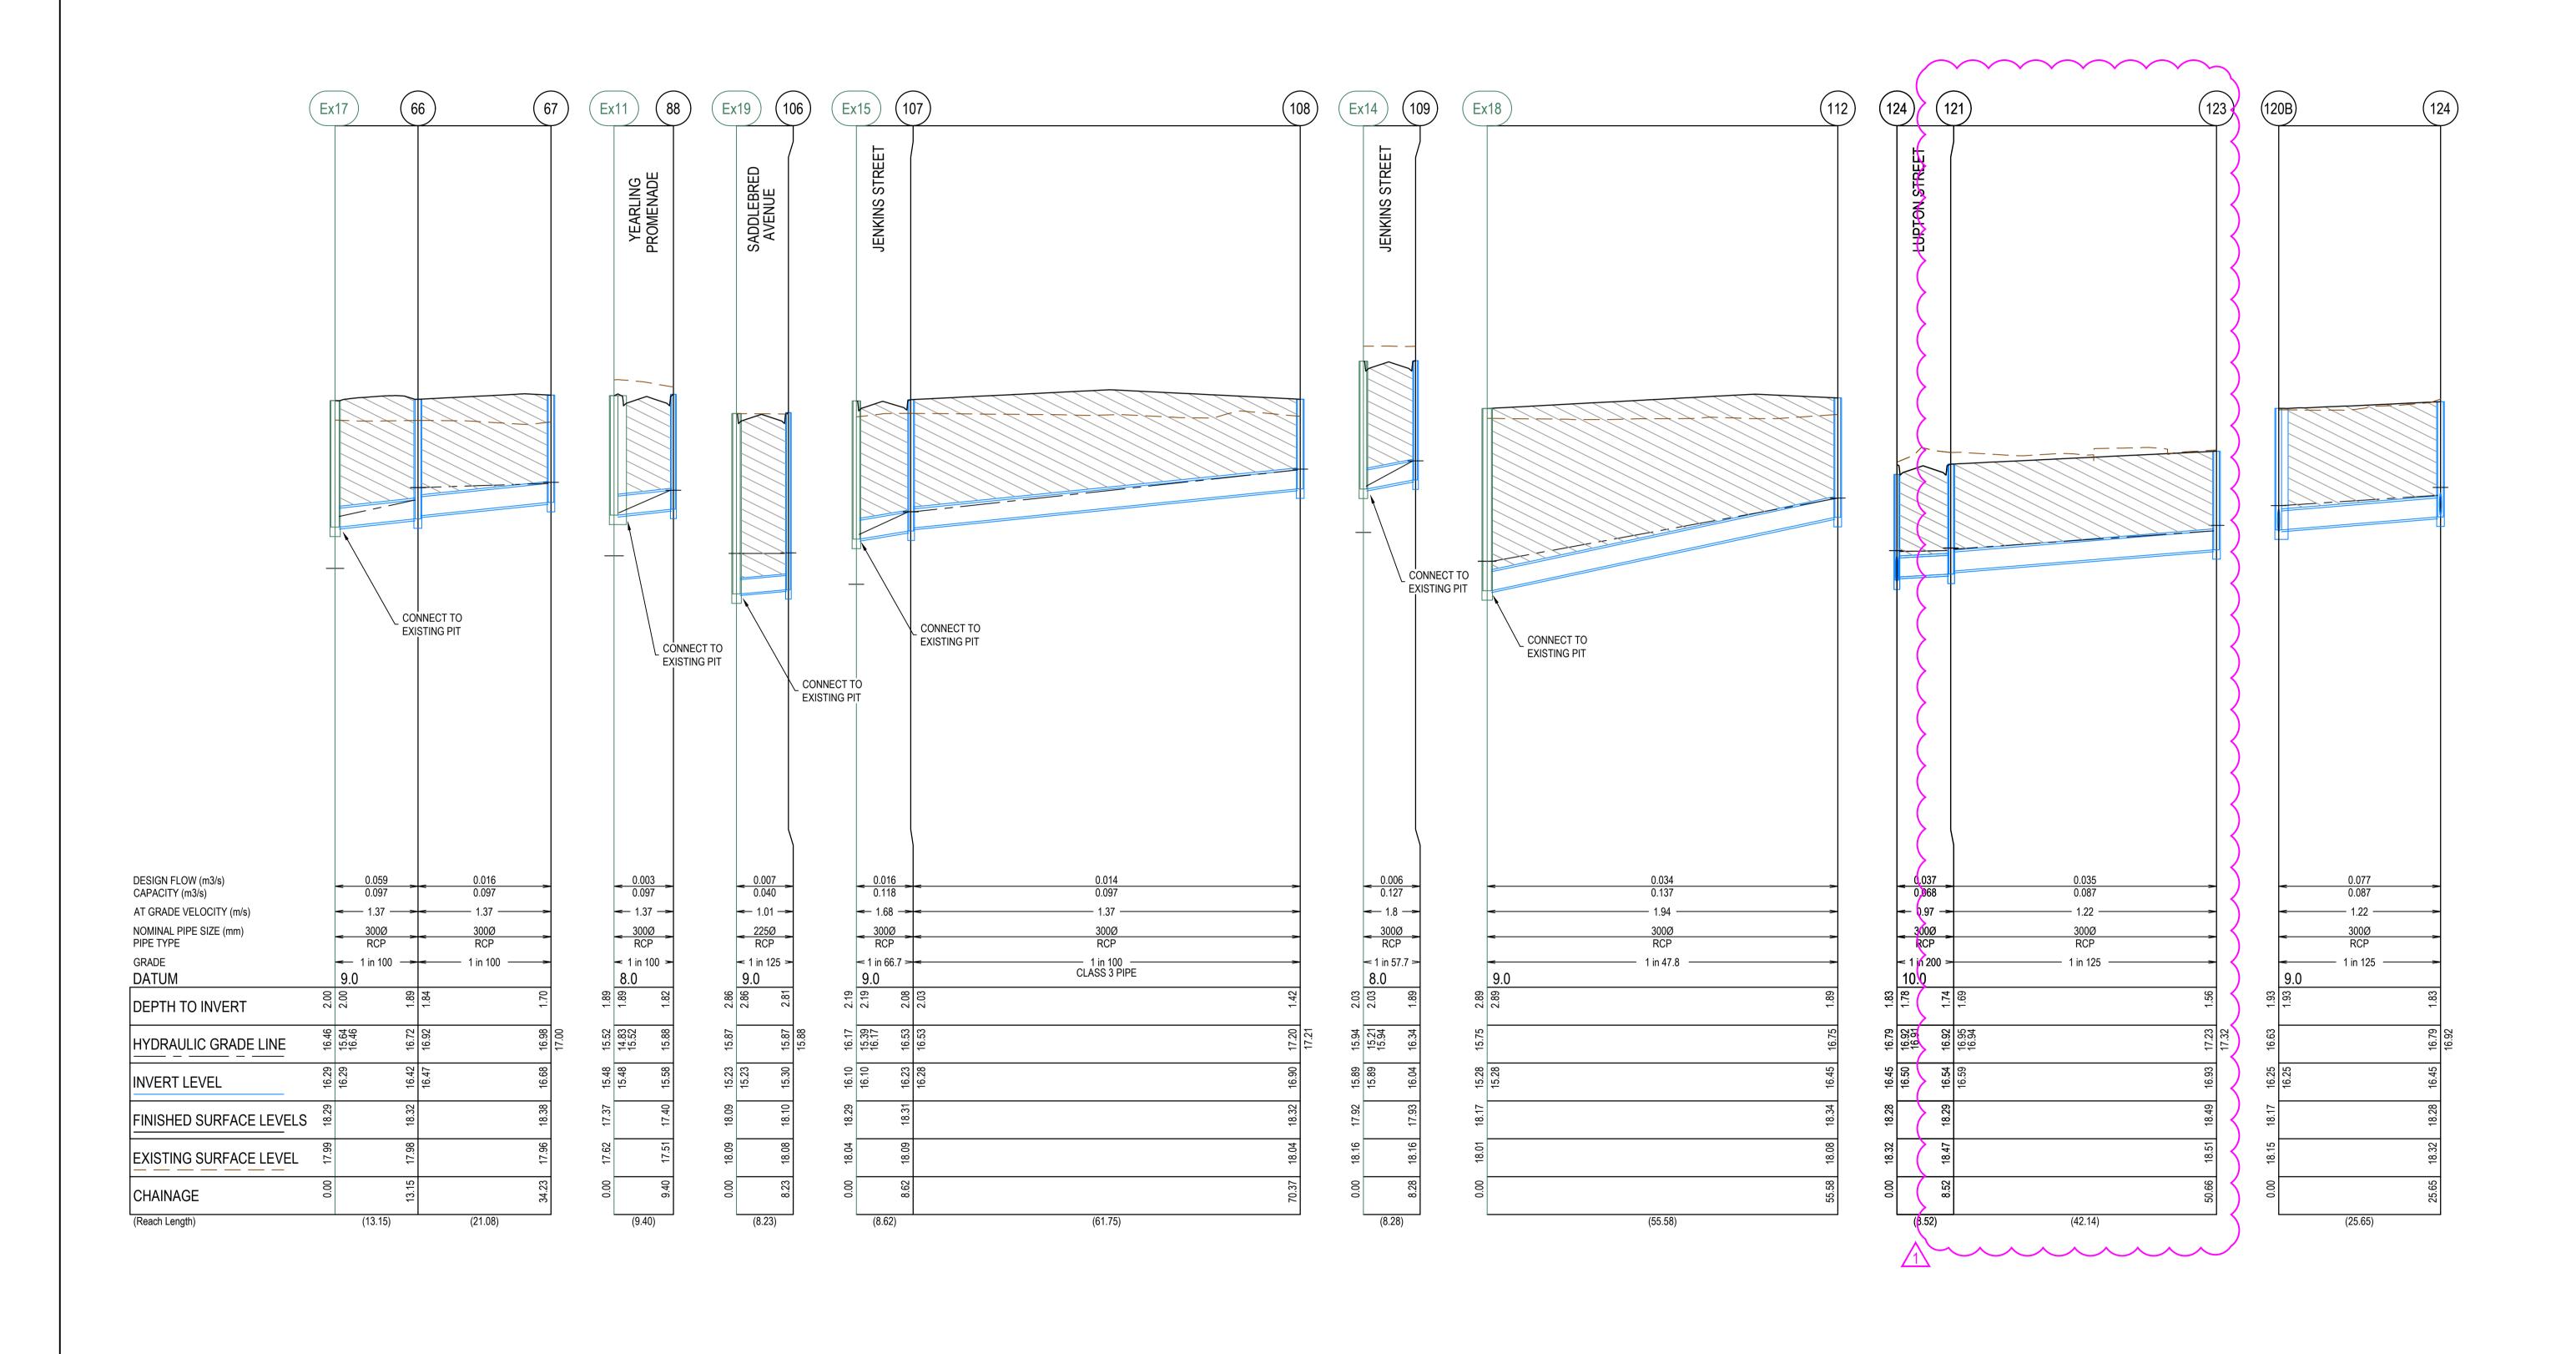
18.08 18.08

-3.80

CH 163.16

CH 151.99



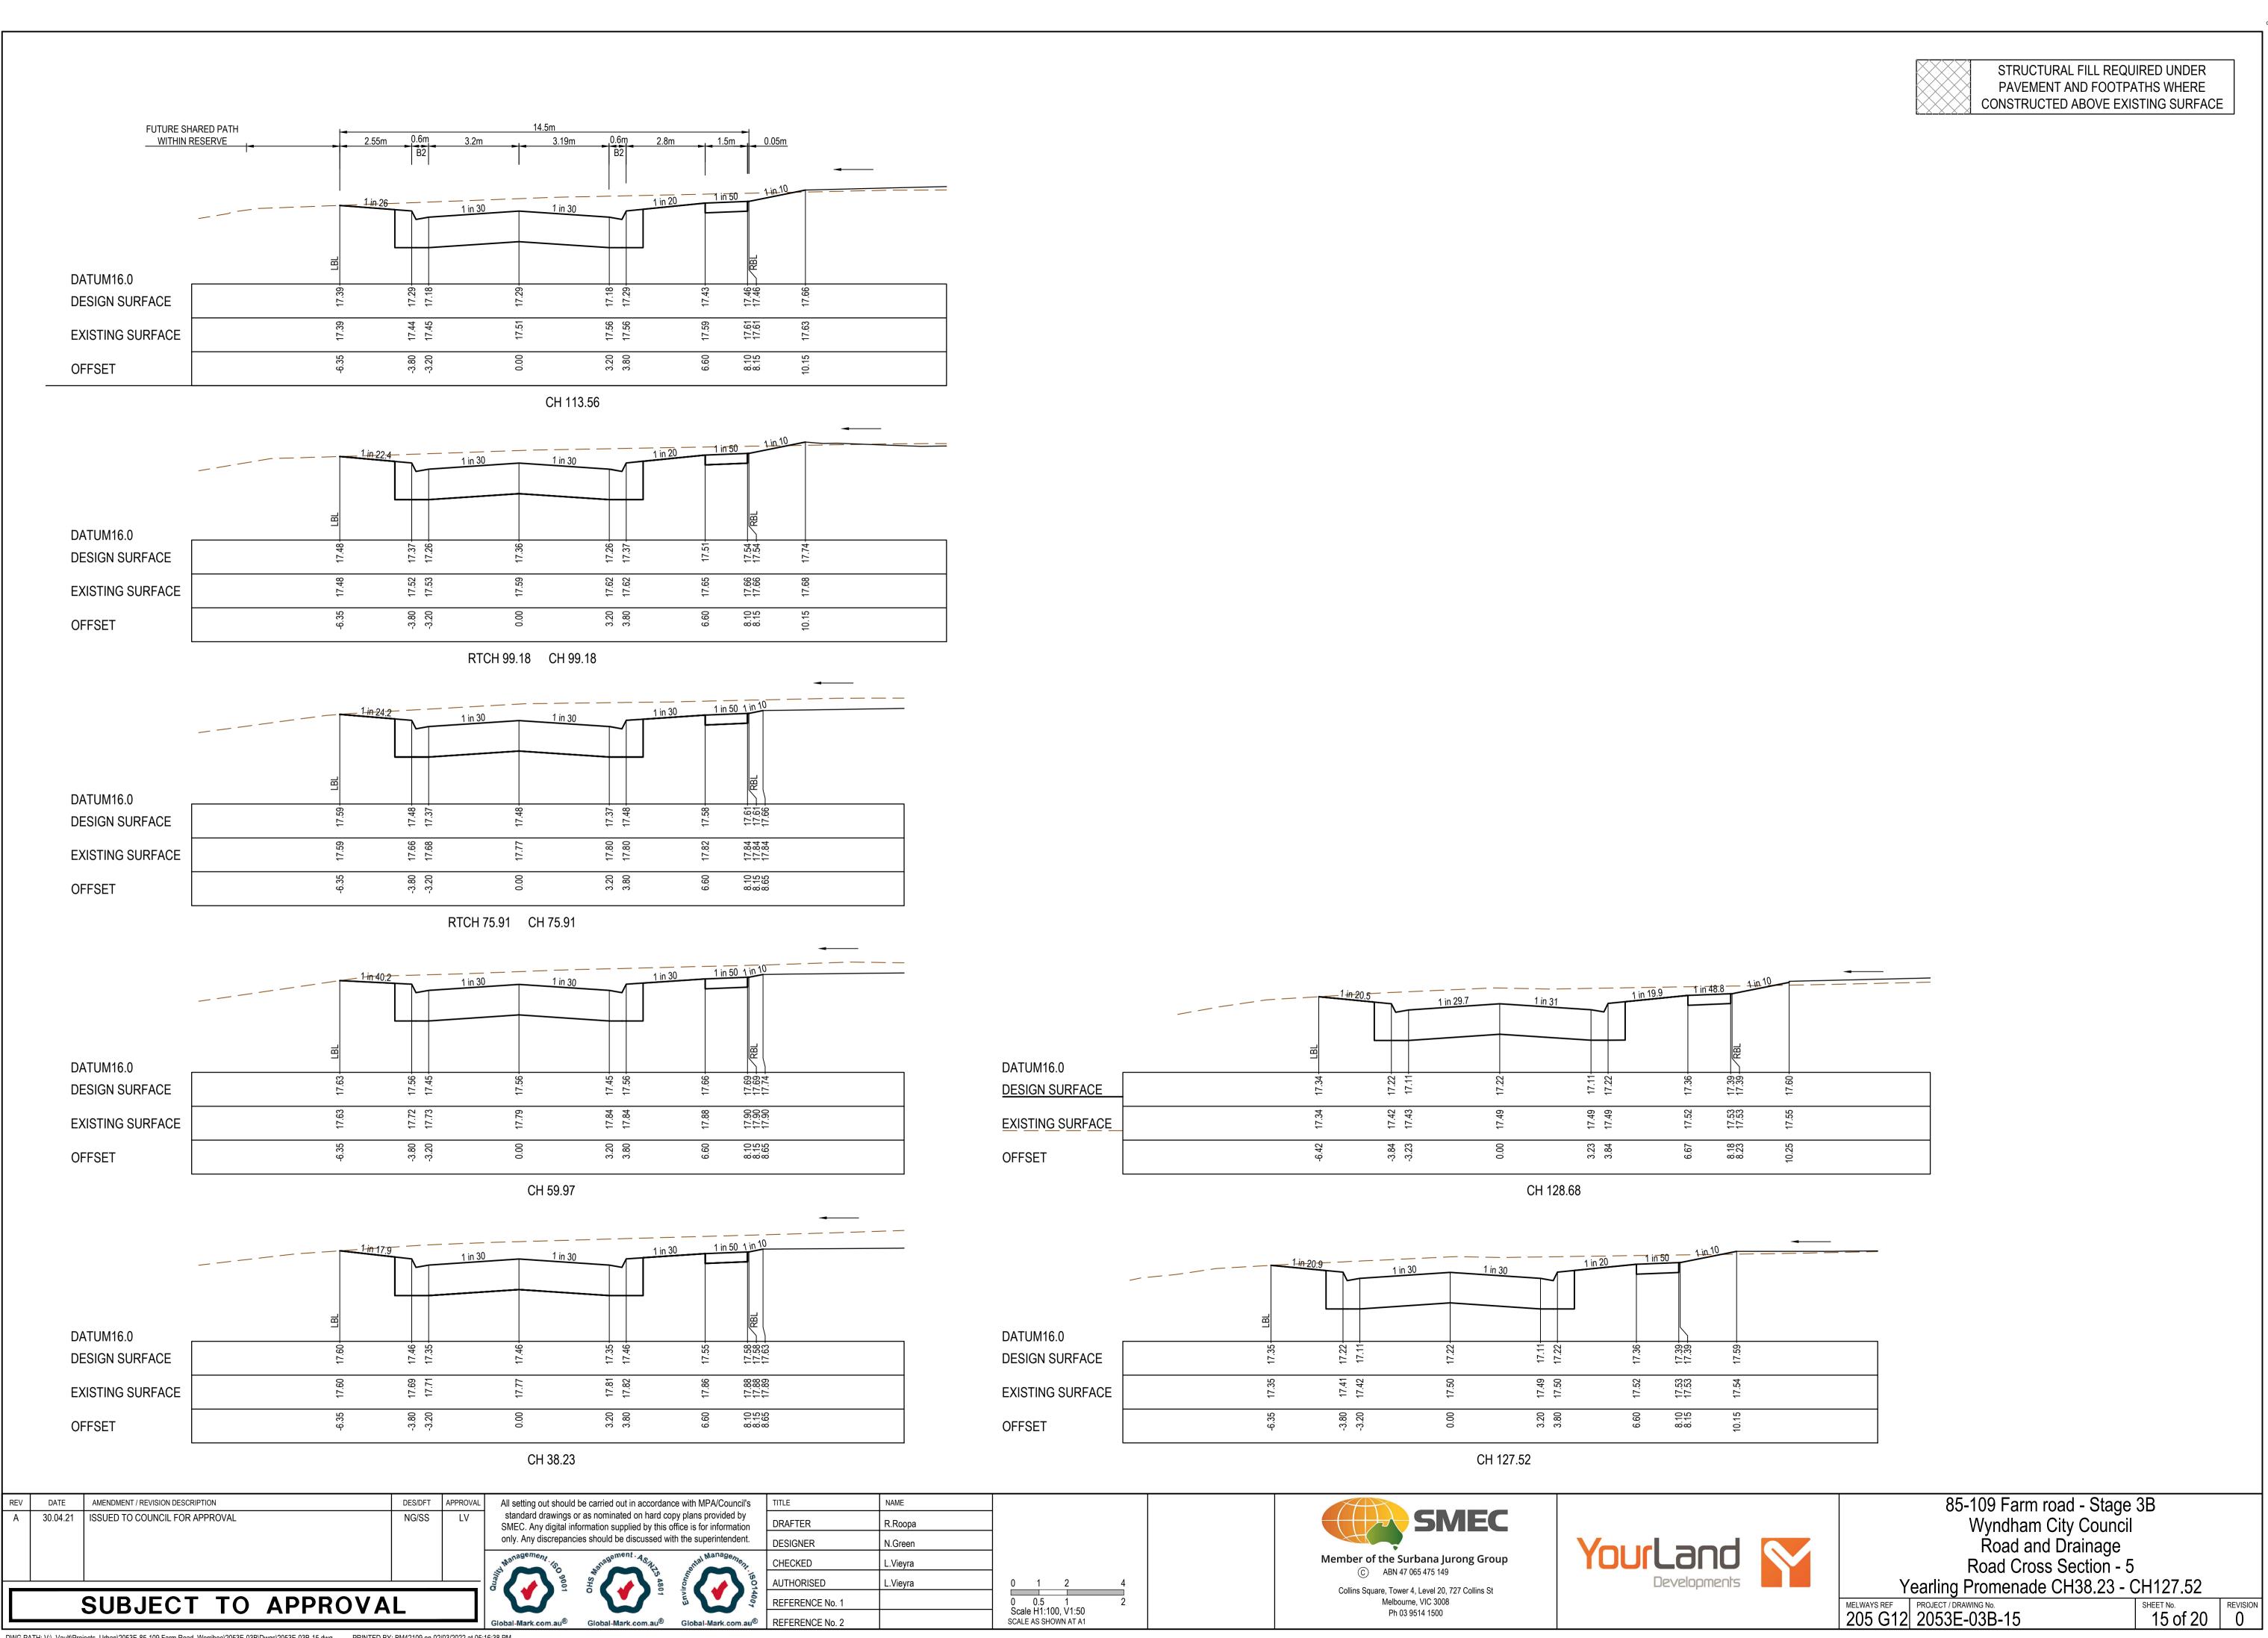

1 25.02.22 LENGTH OF PIPE AND PIT 123 ADDED JD

ISSUED FOR CONSTRUCTION


AMENDMENT / REVISION DESCRIPTION


17.12.21 ISSUED FOR CONSTRUCTION

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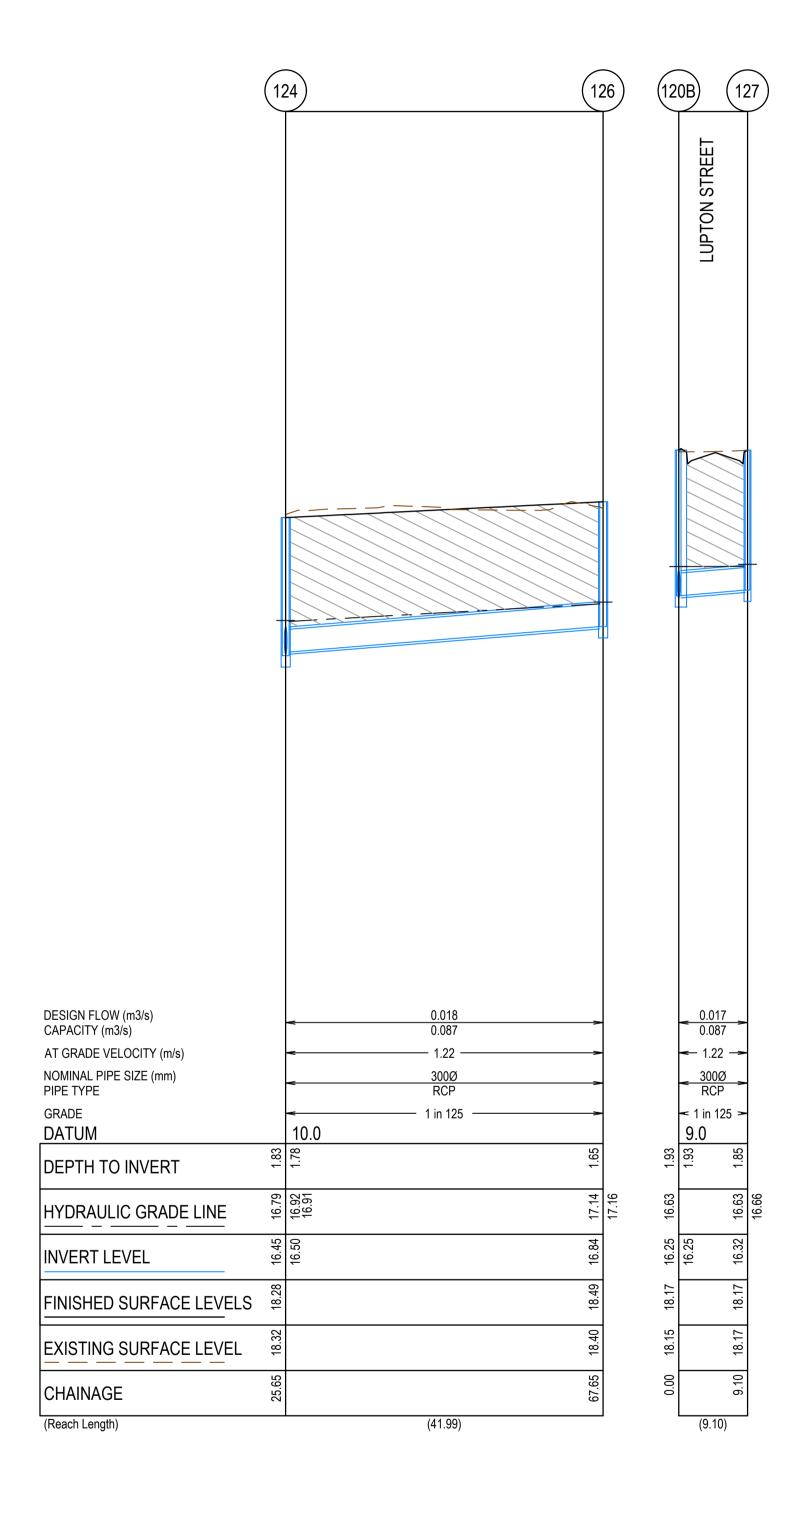


85-109 Farm road - Stage 3B
Wyndham City Council
Road and Drainage
Drainage Longitudinal Section - 1

MELWAYS REF PROJECT / DRAWING No. 205 G12 2053E-03B-16

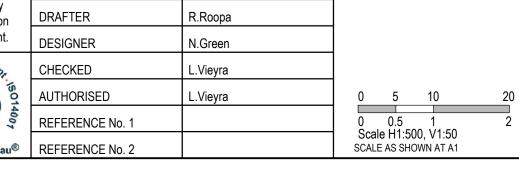SHEET No. R

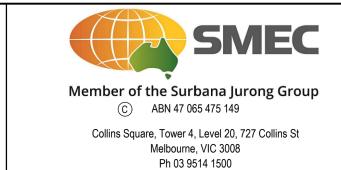NG/SS



							PIT SCHEDULE				
PIT NUMBER	TYPE	INTERNAL		INLET		OUT	LET	F.S.L.	DEPTH	STANDARD	REMARKS
FIT NOWBER	TIFE	WIDTH (mm)	LENGTH (mm)	DIAMETER (mm)	INV R.L. (m)	DIAMETER (mm)	INV R.L. (m)	F.S.L.	DEFIII	DRAWING	NLIVIANNO
17	EX JUCTION PIT	1050	1300	300	16.29			18.295	2.055	EDCM 602	TO BE CONVERTED TO DOUBLE SIDE ENTRY PIT. MATCH PIT COVER TO BACK OF KERB
66	DOUBLE SIDE ENTRY PIT	600	900	300	16.471	300	16.421	18.316	1.895	EDCM 602	
67	JUNCTION PIT	600	900			300	16.682	18.382	1.699	EDCM 605	
11	EX JUCTION PIT	1200	1500	300	15.481			17.371	1.94	EDCM 601	TO BE CONVERTED TO SIDE ENTRY PIT. MATCH PIT COVER TO BACK OF KERB
88	SIDE ENTRY PIT	600	900			300	15.575	17.395	1.82	EDCM 601	
19	EX JUCTION PIT	1200	900	225	15.233			18.09	2.907	EDCM 607	TO BE CONVERTED TO SIDE ENTRY PIT. MATCH PIT COVER TO BACK OF KERB
106	JUNCTION PIT	600	900			225	15.299	18.105	2.806	EDCM 605	
15	EX JUCTION PIT	1050	900	300	16.1			18.291	2.241	EDCM 601	TO BE CONVERTED TO SIDE ENTRY PIT. MATCH PIT COVER TO BACK OF KERB
107	SIDE ENTRY PIT	600	900	300	16.279	300	16.229	18.31	2.081	EDCM 601	
108	DOUBLE SIDE ENTRY PIT	600	900			300	16.897	18.317	1.42	EDCM 602	
14	EX JUCTION PIT	1050	900	300	15.894			17.92	2.076	EDCM 601	TO BE CONVERTED TO SIDE ENTRY PIT. MATCH PIT COVER TO BACK OF KERB
109	SIDE ENTRY PIT	600	900			300	16.038	17.928	1.89	EDCM 601	
18	EX JUCTION PIT	1350	1350	300	15.284			18.17	2.936	EDCM 601	TO BE CONVERTED TO SIDE ENTRY PIT. MATCH PIT COVER TO BACK OF KERB
112	JUNCTION PIT	600	900			300	16,445	18.337	1.891	EDCM 605	PROVIDE CLASS D HEAVY DUTY PIT
124	SIDE ENTRY PIT	600	900	300 X 2	16.502 X 2	300	16.452	18.278	1.826	EDCM 601	
123	SIDE ENTRY PIT	600	900			300	16.932	18.494	1.562	EDCM 601	
121	SIDE ENTRY PIT	600	900	300	16.595	300	16. 545	18.288	1.744	EDEM 601	
120b	DOUBLE GRATED ENTRY PIT	600	900	300	16.247	375	16.197	18.172	1.975	EDCM 602	CONNECT TO EXISTING DRAIN
126	SIDE ENTRY PIT	600	900			300	16.838	18.488	1.65	EDCM 601	
127	DOUBLE SIDE ENTRY PIT	600	900			300	16.32	18.171	1.851	EDCM 602	
80	EX JUNCTION PIT	750	900	450	14.409	450	14.359	17.499	3.139	EDCM 601	TO BE CONVERTED TO SIDE ENTRY PIT. MATCH PIT COVER TO BACK OF KERB
81	EX JUNCTION PIT	750	900	450	14.637	450	14.587	17.51	2.923	EDCM 601	TO BE CONVERTED TO SIDE ENTRY PIT. MATCH PIT COVER TO BACK OF KERB
100	EX JUNCTION PIT	1050	900	450	14.235	525	14.16	17.502	3.343	EDCM 602	TO BE CONVERTED TO DOUBLE SIDE ENTRY PIT. MATCH PIT COVER TO BACK OF KERB
101	EX JUNCTION PIT	600	900	300	15.942	375	15.892	17.647	1.754		MATCH PIT COVER TO BACK OF KERB
12	EX JUNCTION PIT	1500	900	750	14.01	750	14.01	17.5	3.49	EDCM 601	TO BE CONVERTED TO SIDE ENTRY PIT. MATCH PIT COVER TO BACK OF KERB

REV	DATE	AMENDMENT / REVISION DESCRIPTION
0	17.12.21	ISSUED FOR CONSTRUCTION
1	25.02.22	LENGTH OF PIPE AND PIT 123 ADDED

All setting out should be carried out in accordance with MPA/Council's


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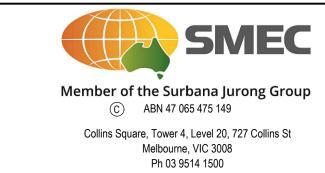
JD

standard drawings or as nominated on hard copy plans provided by SMEC. Any digital information supplied by this office is for information only. Any discrepancies should be discussed with the superintendent.

DRAFTER R.Roopa DESIGNER N.Green L.Vieyra AUTHORISED REFERENCE No. 1

NAME



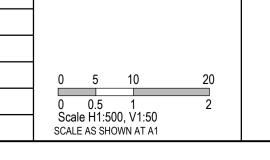





85-109 Farm road - Stage 3B
Wyndham City Council
Road and Drainage
Drainage Longitudinal Section - 2

MELWAYS REF PROJECT / DRAWING No. 205 G12 2053E-03B-17 SHEET No. REVISION 1


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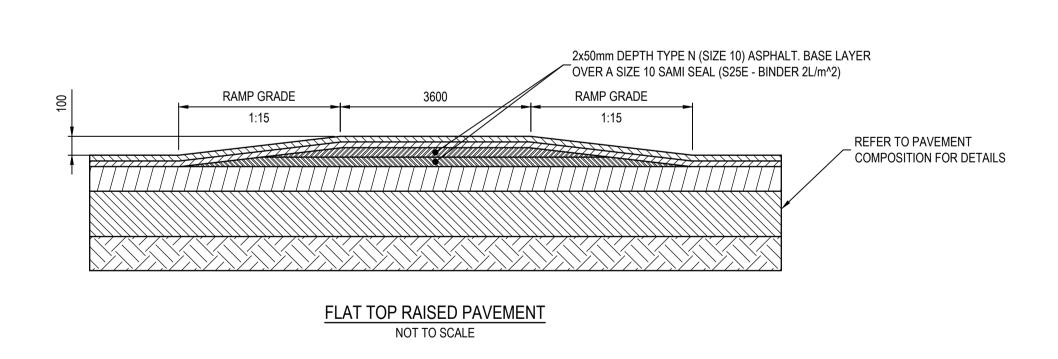


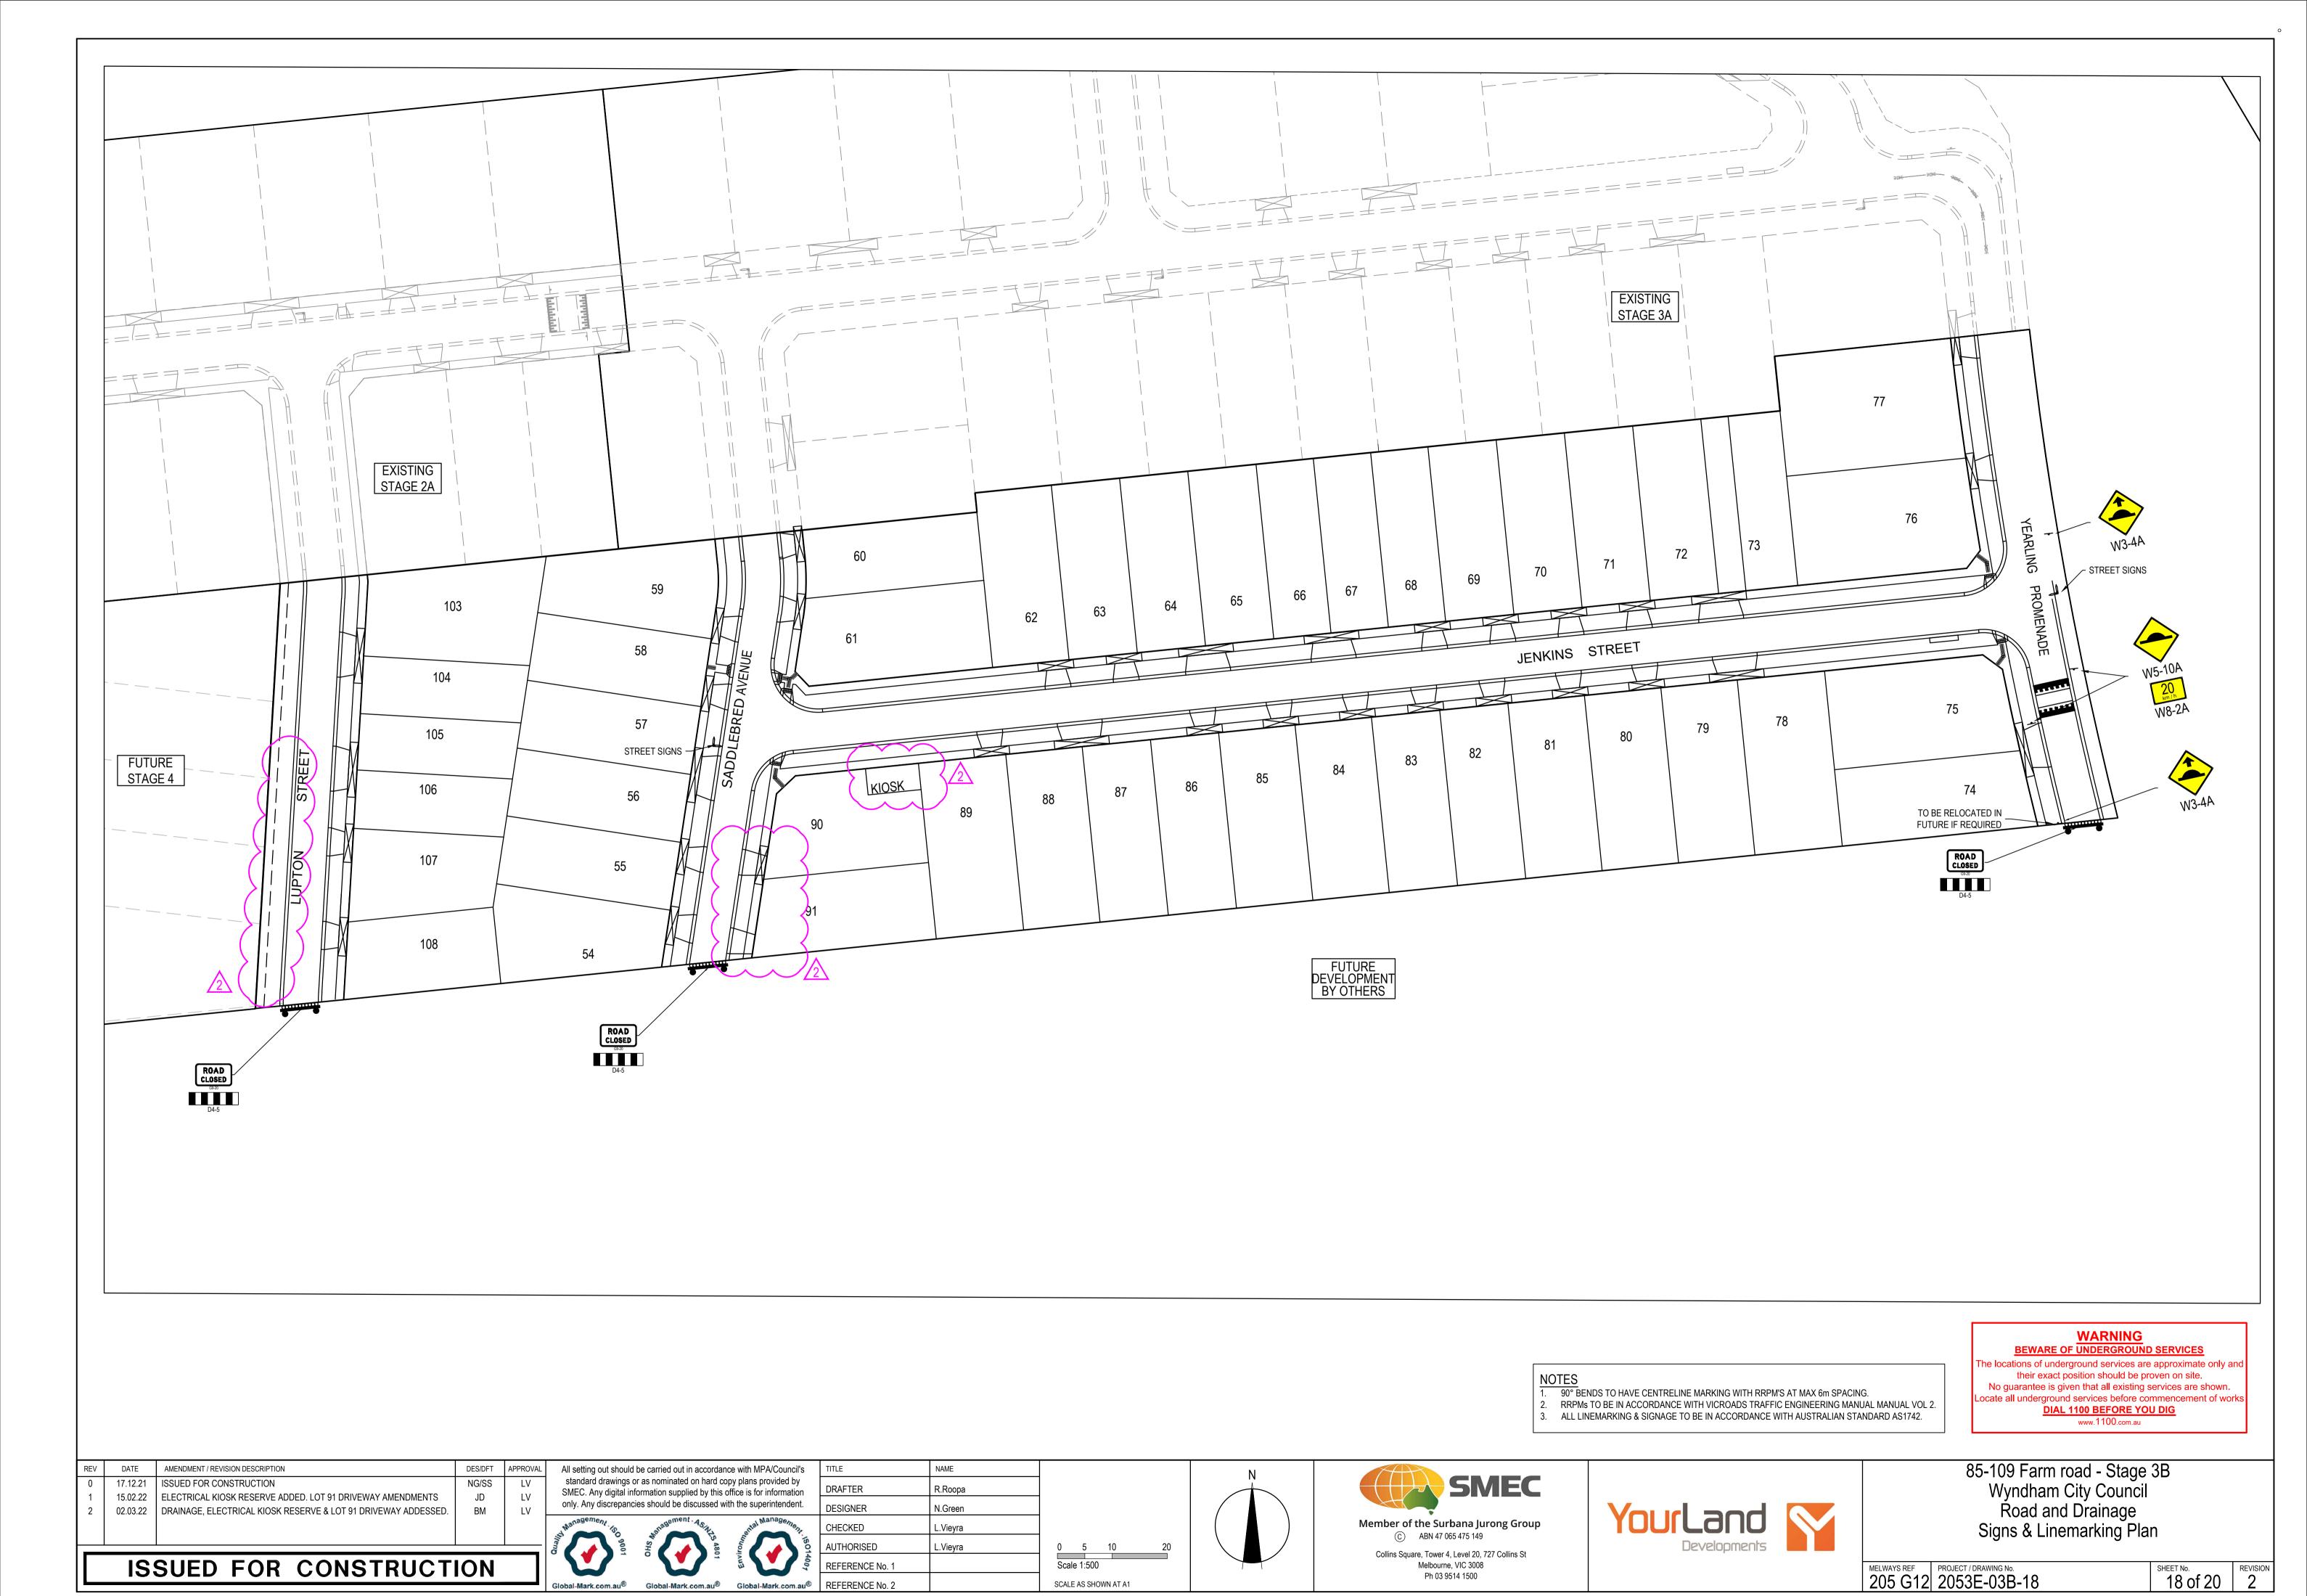


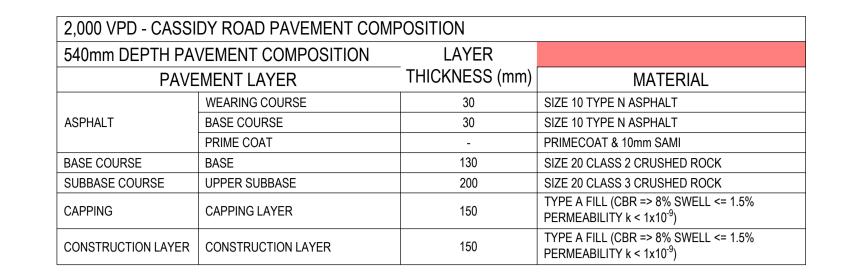

ACCESS TRACK	PAVEMENT COMPOSITION		
200mm DEPTH F	PAVEMENT COMPOSITION	LAYER	
PA	VEMENT LAYER	THICKNESS (mm)	MATERIAL
ASPHALT	WEARING COURSE	30	SIZE 10 TYPE L ASPHALT
BASE COURSE	BASE	170	SIZE 20 CLASS 2 CRUSHED ROCK



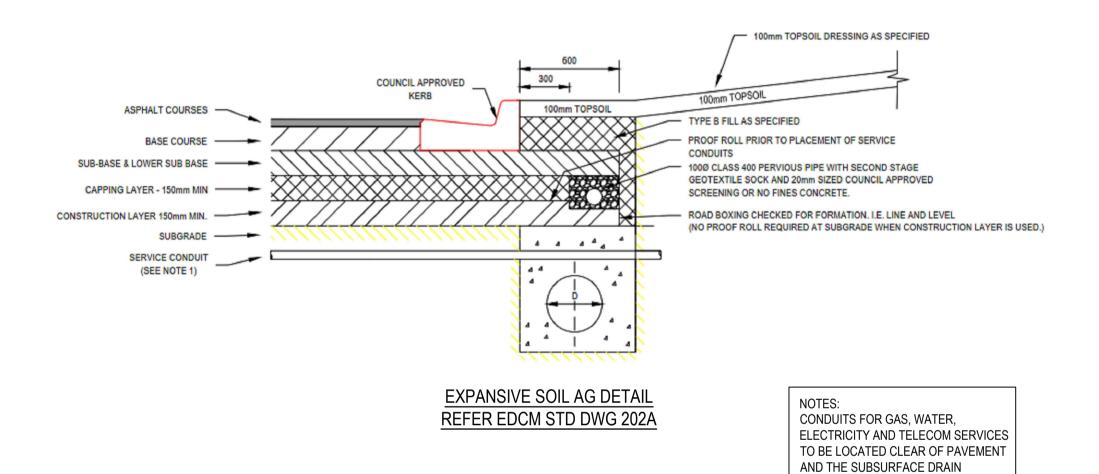

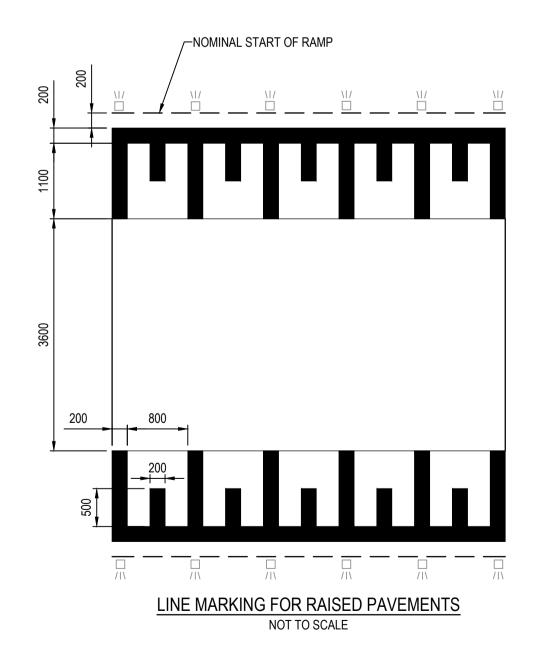

RECYCLED CONCRETE IS NOT ACCEPTABLE MATERIAL IN LIEU OF CLASS 4 FCR

ALL PAVEMENT DESIGNS HAVE BEEN PROVIDED BY GROUND SCINCE. SMEC IS NOT RESPONSIBLE FOR GEOTECHNICAL OR PAVEMENT RELATED DESIGNS AND IS NOT RESPONSIBLE FOR THE ACCURACY, ADEQUACY OR APPROPRIATENESS OF THESE DESIGNS. THE PAVEMENT COMPOSITIONS SHOWN ON THIS DRAWING HAVE BEEN REPRODUCED FROM THE PAVEMENT REPORT FOR THIS DEVELOPMENT STAGE. THIS DOCUMENT SHOULD BE REVIEWED BY THE CONTRACTOR TO ENSURE DESIGN HAS BEEN INTERPRETED CORRECTLY. A COPY OF THIS DOCUMENT WILL BE MADE AVAILABLE ON REQUEST. ANY DIFFERENCES FROM THIS REQUIREMENTS SHOWN ARE TO BE NOTIFIED TO THE SUPERINTENDENT BEFORE PROCEEDING.


SUBJECT TO APPROVAL

AMENDMENT / REVISION DESCRIPTION ISSUED TO COUNCIL FOR APPROVAL ACCESS TRACK PAVEMENT COMPOSITION ADDED 07.06.21

DES/DFT APPROVAL NG/SS NG/SH LV

All setting out should be carried out in accordance with MPA/Council's standard drawings or as nominated on hard copy plans provided by SMEC. Any digital information supplied by this office is for information only. Any discrepancies should be discussed with the superintendent.

DRAFTER R.Roopa DESIGNER N.Green _.Vieyra AUTHORISED REFERENCE No. 1

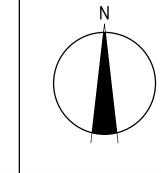

0 10 20 Scale 1:1000

SCALE AS SHOWN AT A1



Collins Square, Tower 4, Level 20, 727 Collins St Melbourne, VIC 3008 Ph 03 9514 1500



he locations of underground services are approximate only and their exact position should be proven on site. No guarantee is given that all existing services are shown. ocate all underground services before commencement of works DIAL 1100 BEFORE YOU DIG www.1100.com.au

WARNING
BEWARE OF UNDERGROUND SERVICES

85-109 Farm road - Stage 3B Wyndham City Council Road and Drainage Pavement Details


MELWAYS REF PROJECT / DRAWING No. 2053E-03B-19

19 of 20


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Project Name:		sign Package: 2053E-01										
Farm Road- Stage 3B	Date: Feb 2020								Deside	Desident		
<u>PHASE</u>	DISCIPLINE CODE		uction- Operations- Maintenance ENTIAL RISK	RISK OWNER	POTENTIAL CONSEQUENCES	POTENTIAL ELIMINATION MEASURE, DESIGN INITIATIVE or CONTROL (Identify any Standard or Code of practice used)	HOW ISSUE ADDRESED IN DESIGN AND/OR CONSTRUCTION OF THE WORKS	IS THE RISK ELIMINATED YES/NO	al Risk		Residu	RESIDUAL RISK OWNER
		Road Furniture / Roadside features										
Construction	RD Roads	Construction close to live traffic	New works will be constructed adjacent to live traffic when abutting existing stages.	Contractor	Disruptions to live traffic, construction incident involving live traffic.	Provide safe temporary traffic control (TCP)	TCP provided within contract	N	5	3	15	Constructor
Construction	US Utilities or Services	Utilities become a hazard within clear zones	Vehicle conflict with utility / pit	Contractor	Personal injury, vehicle damage	Sequence works and protect with temp barrier or traffic control (TCP)	TCP provided within contract	N	1	5	5	Constructor
Operational	RD Roads	Sight Lines	Inadequate drivers response time.	Road Authority	Increased potential for accidents	Ensure design complies with relevant standard. Undertake thorough Safety Audit	Vis lines checked and discussed with approval authority as part of design approval process	N	1	4	4	Road Authority
•		Signs and atract lights	Potential for drivers / riders to strike signs and street	Road Authority	Ingraced natential for accidents	Ensure design complies with relevant standard. Undertake	Pefer to appropriate standard for sign and lighting effects					Road Authority
Operational Operational	LS Lines and Signs	Signs and street lights	lights Determined webside conflict within allow room.	Road Authority	Increased potential for accidents Increased potential for accidents	thorough Safety Audit Establish adequate clear zone provision	Refer to appropriate standard for sign and lighting offsets Adequate barrier provided as per appropriate standard where within clear zone. Culvert headwall selection in accordance with authority standard	N	1	4	4	Road Authority
Орегаціона	RF Road Furniture	Headwalls	Potential vehicle conflict within clear zone	Road Admonty	increased potential for accidents	Establish adequate clear zone provision	accordance with authority standard	N	2	4	8	Road Admonty
Operational	DR Drainage	Drainage Grated Pits	Trip/fall hazard with large spaced grate	Relevant Authority	Increased potential for accidents	Provide pedestrian/bicycle friendly grates where applicable. Refer to pit schedule	Design in accordance with authority and manufacturers standards	N	3	2	6	Authority
Operational	DR Drainage	Non Standard Large Pits	Potential for pit failure	Relevant Authority	Increased risk to maintenance crews/ vehicles	Structural design in accordance with relevant design principles.	Refer to structural drawings and calculations	N	1	4	4	Authority
Operational	DR Drainage		Potential for falling from height	Relevant Authority	Increased potential for accidents	Fencing to be provided where culverts/headwalls are at height in accordance with relevant authority standards	Allow for fencing in Design Process			,		Authority
Operational	DR Drainage	Culvert Endwalls/Headwalls Culvert Endwall/Headwall Outlets	Children playing in large pipes / watercourses and access for maintenance		Increased potential for accidents	Grate provided to authority standards	Design in accordance with authority and manufacturers standards	N	2	5	10	Authority
Maintenance	DR Drainage	Access to Pits	Lack of safe access for maintenance	Relevant Authority	Increased risk to maintenance crews	Provide safe working conditions for maintenance. Provide safe landing/ access arrangements as per relevant authority standards	Where possible design pit in location for easy access and outside of permanent water bodies	N	2	5	10	Authority
Maintenance	DR Drainage	Deep Pits	Lack of safe entry for maintenance	Relevant Authority	Increased potential for accidents	Contractor to be certified for work in confined spaces, step irons to be provided to appropriate authority standards. Refer to pit schedule	Design in accordance with authority standards	N	1	5	5	Authority
Maintenance	DR Drainage	Access to drains / culverts	Lack of safe access for maintenance	Relevant Authority	Increased risk to maintenance crews	Provide safe working conditions for maintenance. Access as approved by authority	Design pit in location for easy access as agreed with authority	N	2	3	6	
		Sewer										
Construction	SE Sewer	Sewer Manhole located adjacent to Retaining Wall Alignment	Falling from height during construction or commissioning of adjacent sewer manholes	Contractor	Falling from a height	Provide temporary fencing until such time that permanent fencing is constructed	Provide fencing (at heights) during design process	N	1	1	1	Constructor
Maintenance	SE Sewer	Deep Manholes	Lack of safe entry for maintenance	Relevant Authority	Increased potential for accidents	Contractor to be certified for work in confined spaces, landings and step access provided as per authority standards and schedule	Design in accordance with authority standards. Refer pit schedule on drawings	N	1	5	5	Authority
Maintenance	SE Sewer	Access to Manholes	Lack of safe access for maintenance	Relevant Authority	Increased risk to maintenance crews	Provide safe working conditions for maintenance. Manholes located in compliance with authority standards	Where possible design manhole in location for easy access	N	1	5	5	Authority
Maintenance	SE Sewer	Pump Station Access	Lack of safe access for maintenance	Relevant Authority	Increased risk to maintenance crews	Provide safe working conditions for maintenance	Design pump station in location for easy access	N	2	4	8	Authority
		Electricity										
Operational	ES Electrical Services	Electrical Design	Location of assets within clear zones e.g., pits/ substations	Relevant Authority	Increased potential for accidents	Electrical designed by sub consultant with appropriate accreditation and in accordance with authority standards	Pits designed below ground. Where above ground adequate offset from vehicle clear zones has been provided or barrier protection provided	N	2	3	6	Authority
		Telstra										
Operational	TE Telstra	Telstra Design	Location of assets within clear zones e.g., pits	Relevant Authority	Increased potential for accidents	Telecommunications designed by authority consultant with appropriate accreditation and in accordance with authority standards	Pits designed below ground. Where above ground adequate offset from vehicle clear zones has been provided or barrier protection provided	N	2	3	6	Authority
	TE TOIGHT	Water	2 2.9		a personal accidente	- Contract wo		14	_			,
Operational	WA Water	Water Design	Location of assets within clear zones e.g., pits/ substations	Relevant Authority	Increased potential for accidents	Water pits designed in accordance with authority standards	Pits designed below ground. Where above ground adequate offset from vehicle clear zones has been provided or barrier protection provided	N	2	3	6	Authority
	VVA WATEI		Substations	. Islanding		The production in account of the data of t	Processor Statement Processor Processor	IN		3	J	. idanomy
Operational	CA Coo	Gas Design	Location of assets within clear zones e.g., pits/	Relevant Authority	Increased potential for accidents	Water pits designed in accordance with authority standards	Pits designed below ground. Where above ground adequate offset from vehicle clear zones has been provided or barrier protection provided	NI NI	1	1	1	Authority
ореганопа	GA Gas	Jas Design	substations	Relevant Authority	inoreased potential for accidents	vvater pits designed in accordance with authority standards	provided of partier protection provided	IN IN	1	1	1	Authority

	ISSUED FOR CONSTRUCTION										
0	16.12.21	ISSUED FOR CONSTRUCTION		J.D	L.V						
REV	DATE	AMENDMENT / REVISION DESCRIPTION		DES/DFT	APPROVAL						



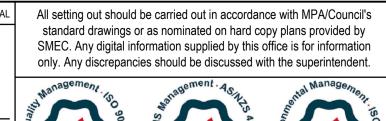



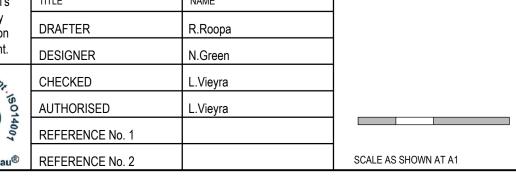



85-109 Farm road - Stage 3B
Wyndham City Council
Road and Drainage
Safety In Design
Safety In Design

MELWAYS REF PROJECT / DRAWING No. 205 G12 LND/20/00819/55

SHEET No. REVISION 0